

NOTICE OF INTENT MASCONOMET REGIONAL SCHOOL DISTRICT SYNTHETIC TURF FIELDS 20 ENDICOTT ROAD

PROJECT NO. 210801991 ISSUED: JANUARY 18, 2024

BOXFORD, MA 01921

APPLICANT / OWNER

MASCONOMET REGIONAL SCHOOL DISTRICT 20 ENDICOTT ROAD BOXFORD, MA 01921

LANDSCAPE ARCHITECT / CIVIL ENGINEER

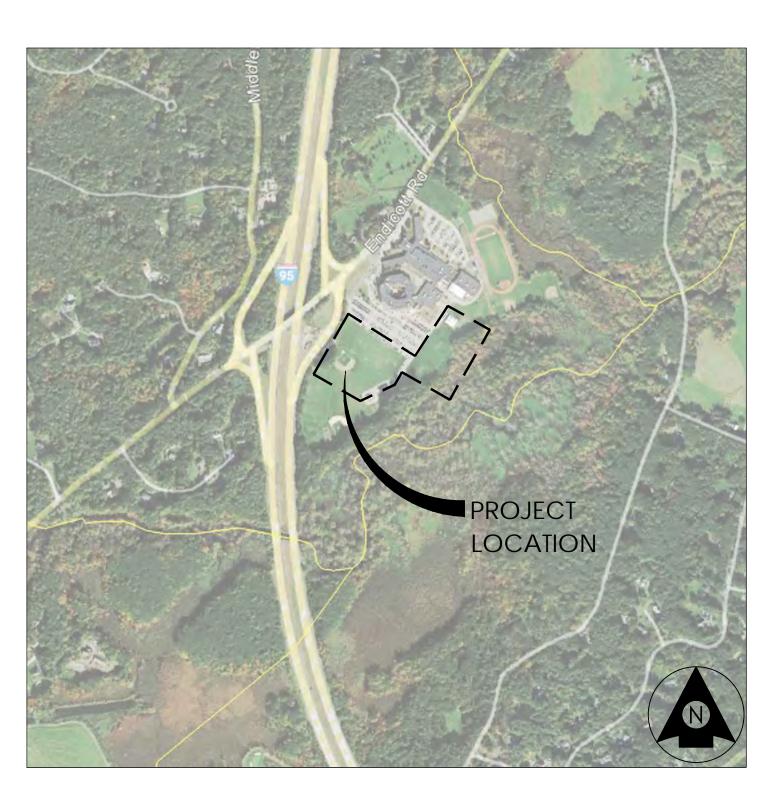
STANTEC PLANNING AND LANDSCAPE ARCHITECTURE P.C. 40 WATER STREET, 3RD FLOOR BOSTON, MA 02109

ARCHITECT

STANTEC 45 NETWORK DRIVE BURLINGTON, MA 01803

SURVEYOR

PRECISION LAND SURVEYING INC. 32 TURNPIKE ROAD SOUTHBOROUGH, MA 01772



VICINITY MAP


NOT TO SCALE


INDEX OF SHEETS


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| SHEET NO. | TITLE |
| EX-101 | EXISTING CONDITIONS PLAN |
| GI-101 | OVERALL SITE PLAN |
| LD-101 | SITE PREPARATION PLAN |
| LS-101 | LAYOUT AND MATERIALS PLAN |
| LS-102 | WALL AND FENCE LAYOUT PLAN |
| LG-101 | GRADING PLAN |
| CU-101 | DRAINAGE AND GRADING PLAN |
| LP-101 | PLANTING PLAN |
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| LS-501 | SITE DETAILS I |
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| LS-504 | SITE DETAILS IV |
| LP-501 | PLANTING DETAILS |
| CU-501 | UTILITY DETAILS |
| | |

| BOXFORD CONSERVATION COMMISSION NOTICE OF INTENT |
|--|
| OWNER: MASCONOMET REGIONAL SCHOOL DISTRICT |
| 20 ENDICOTT ROAD, BOXFORD, MA 01921 |
| TAX MAP 43 BLOCK 01 LOT 01 |
| DESCRIPTION: IMPROVEMENTS TO EXISTING ATHLETIC FIELDS |
| REVISIONS: |
| ISSUED FOR NOTICE OF INTENT - 01.18.2024 |
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| 01.18.2024 |
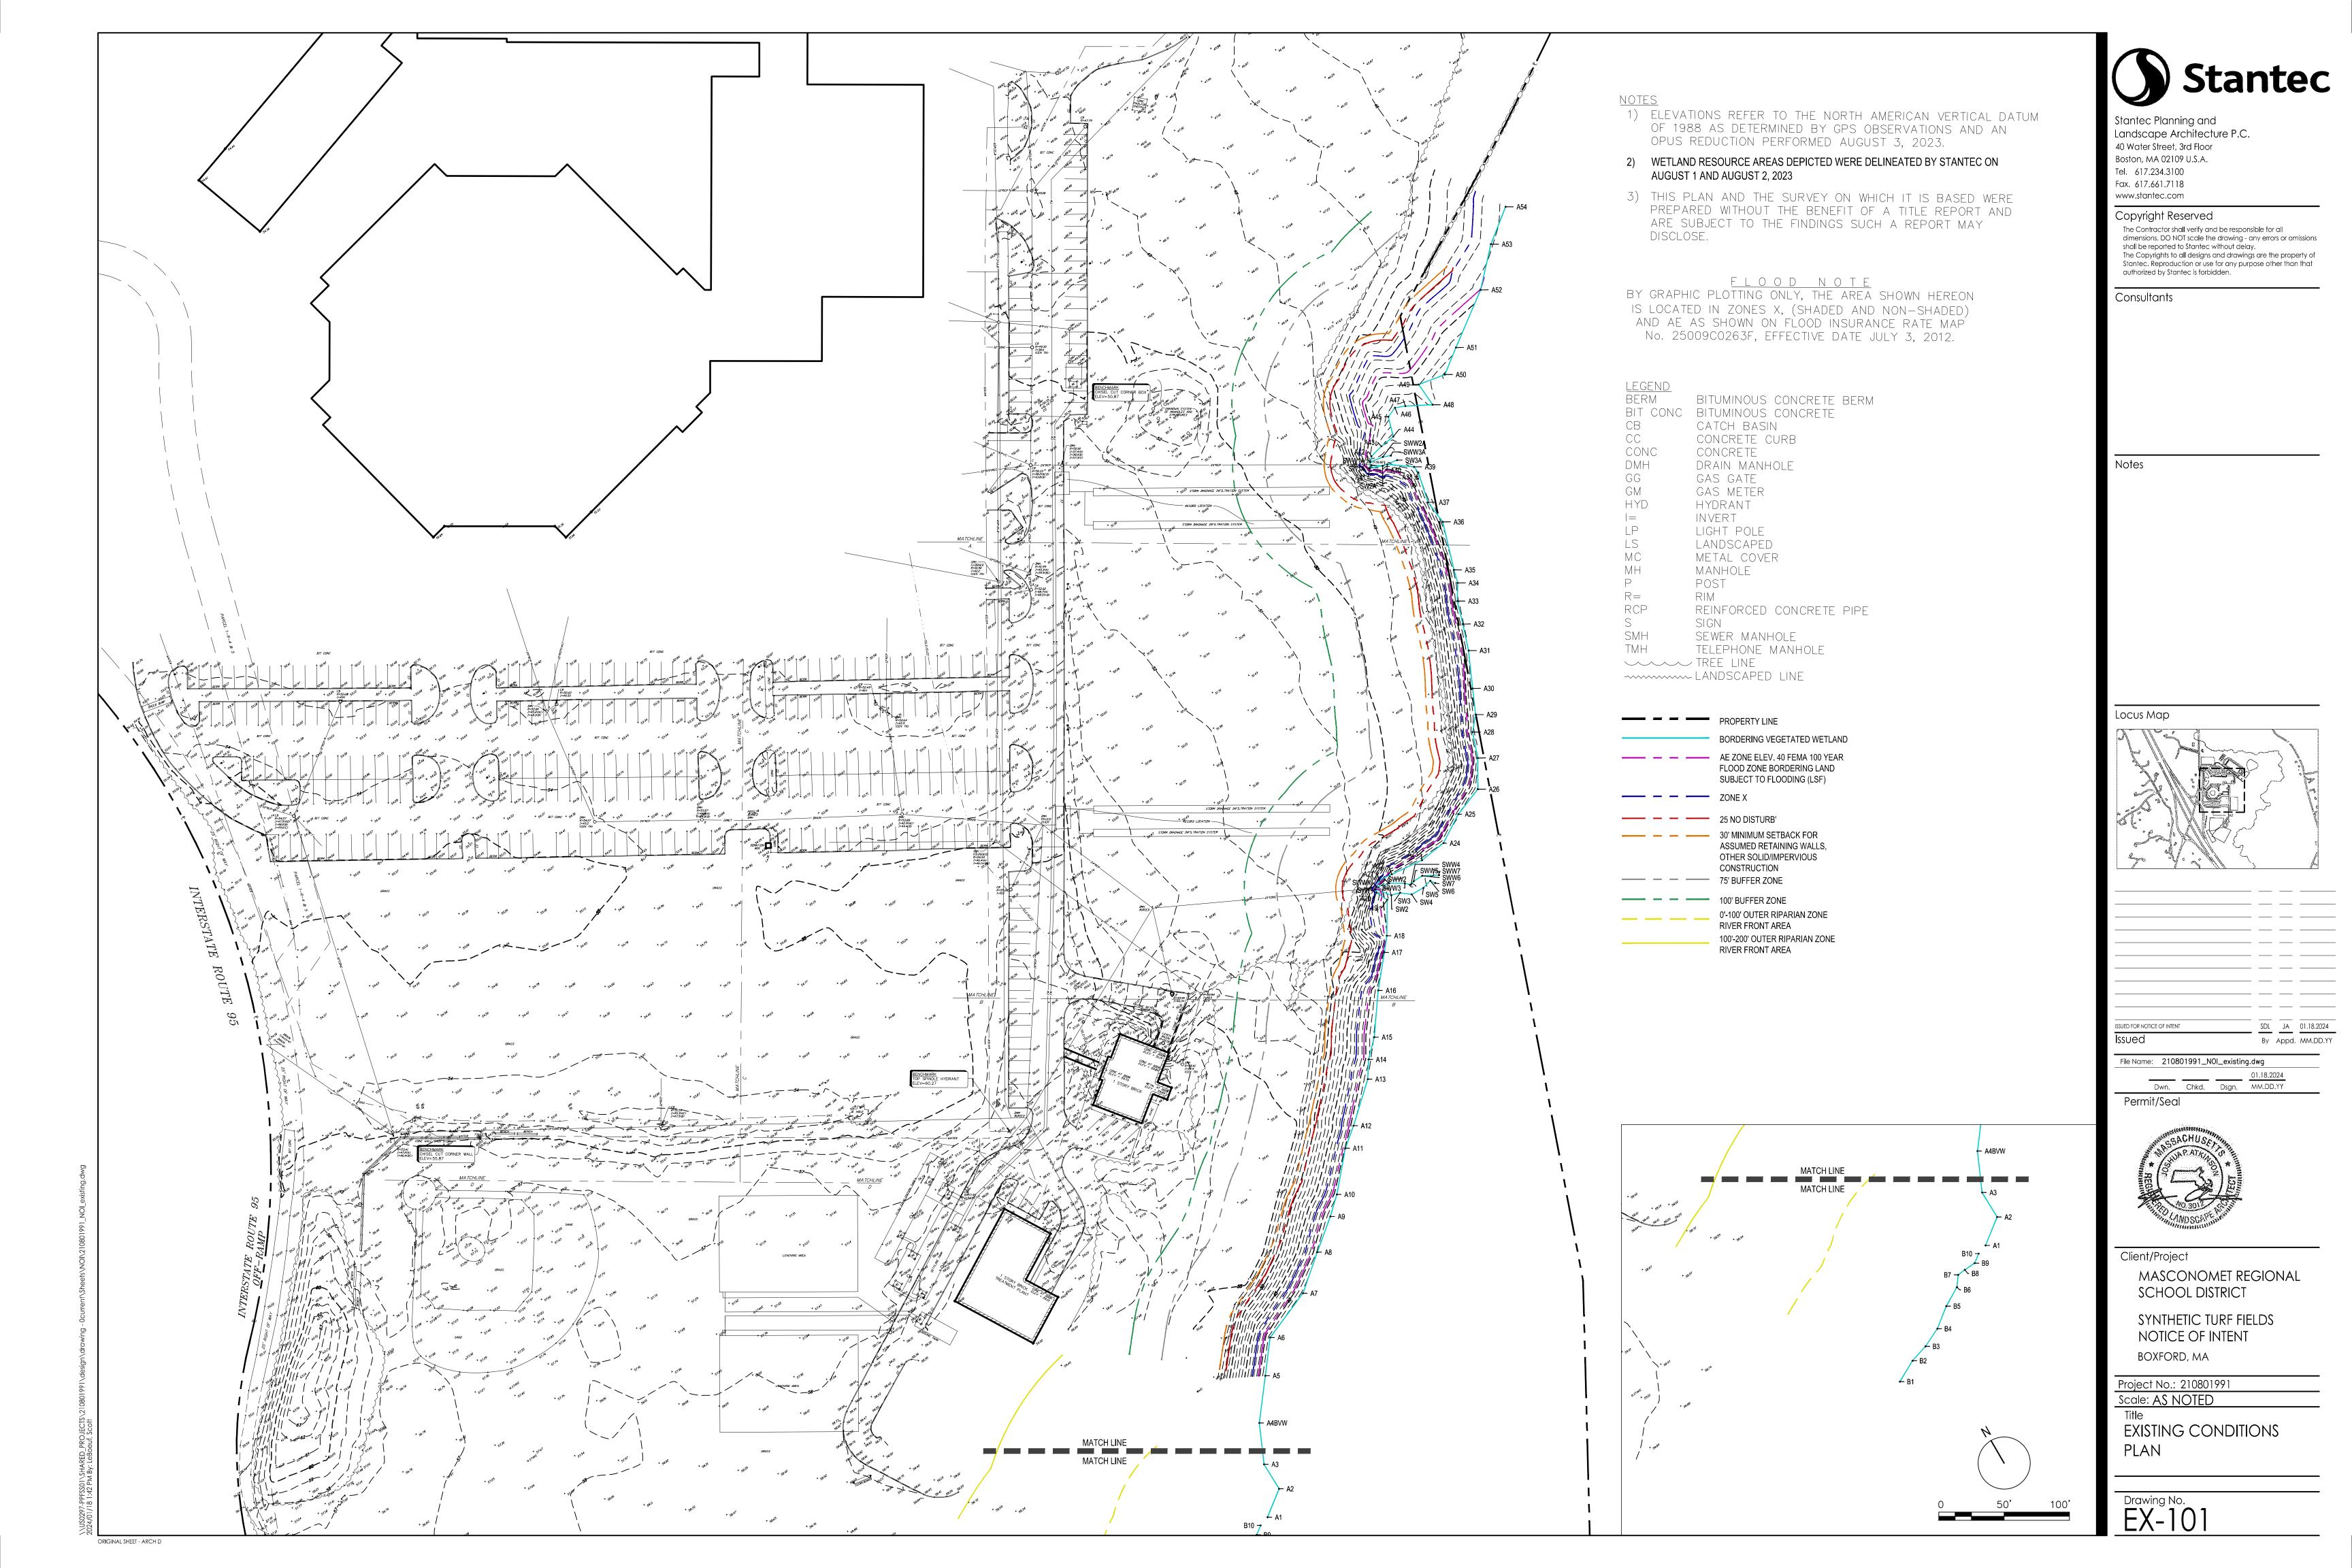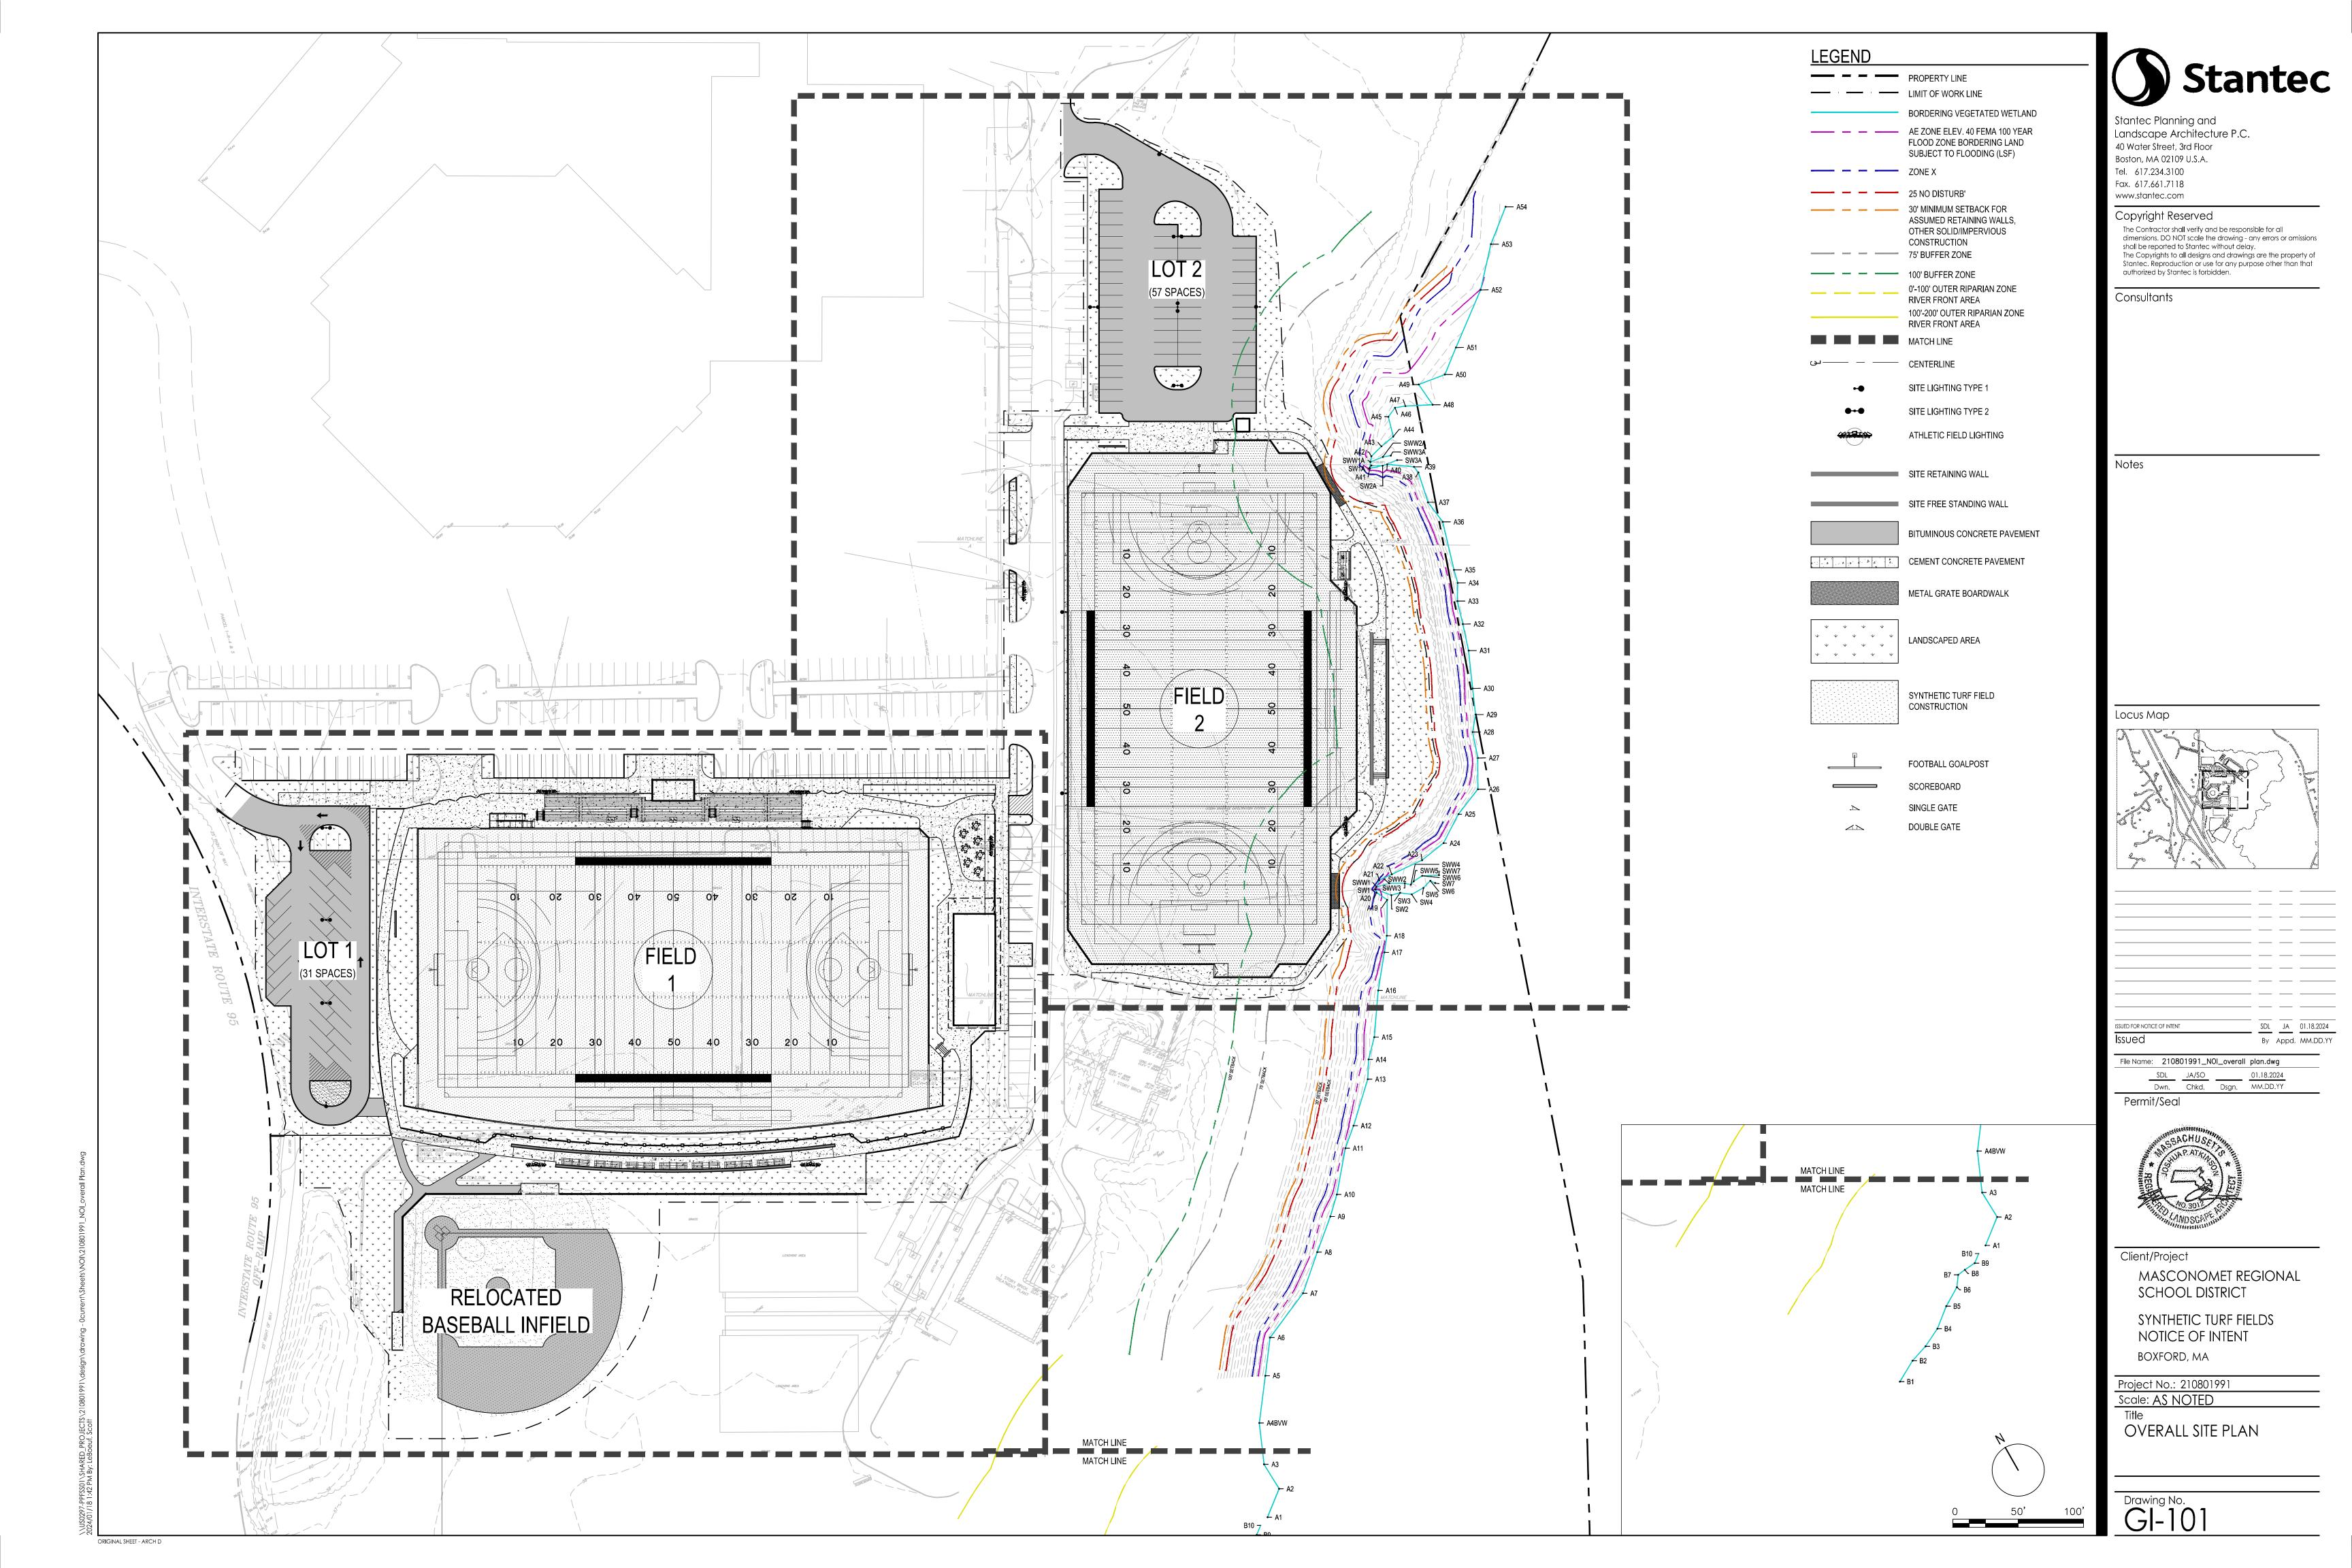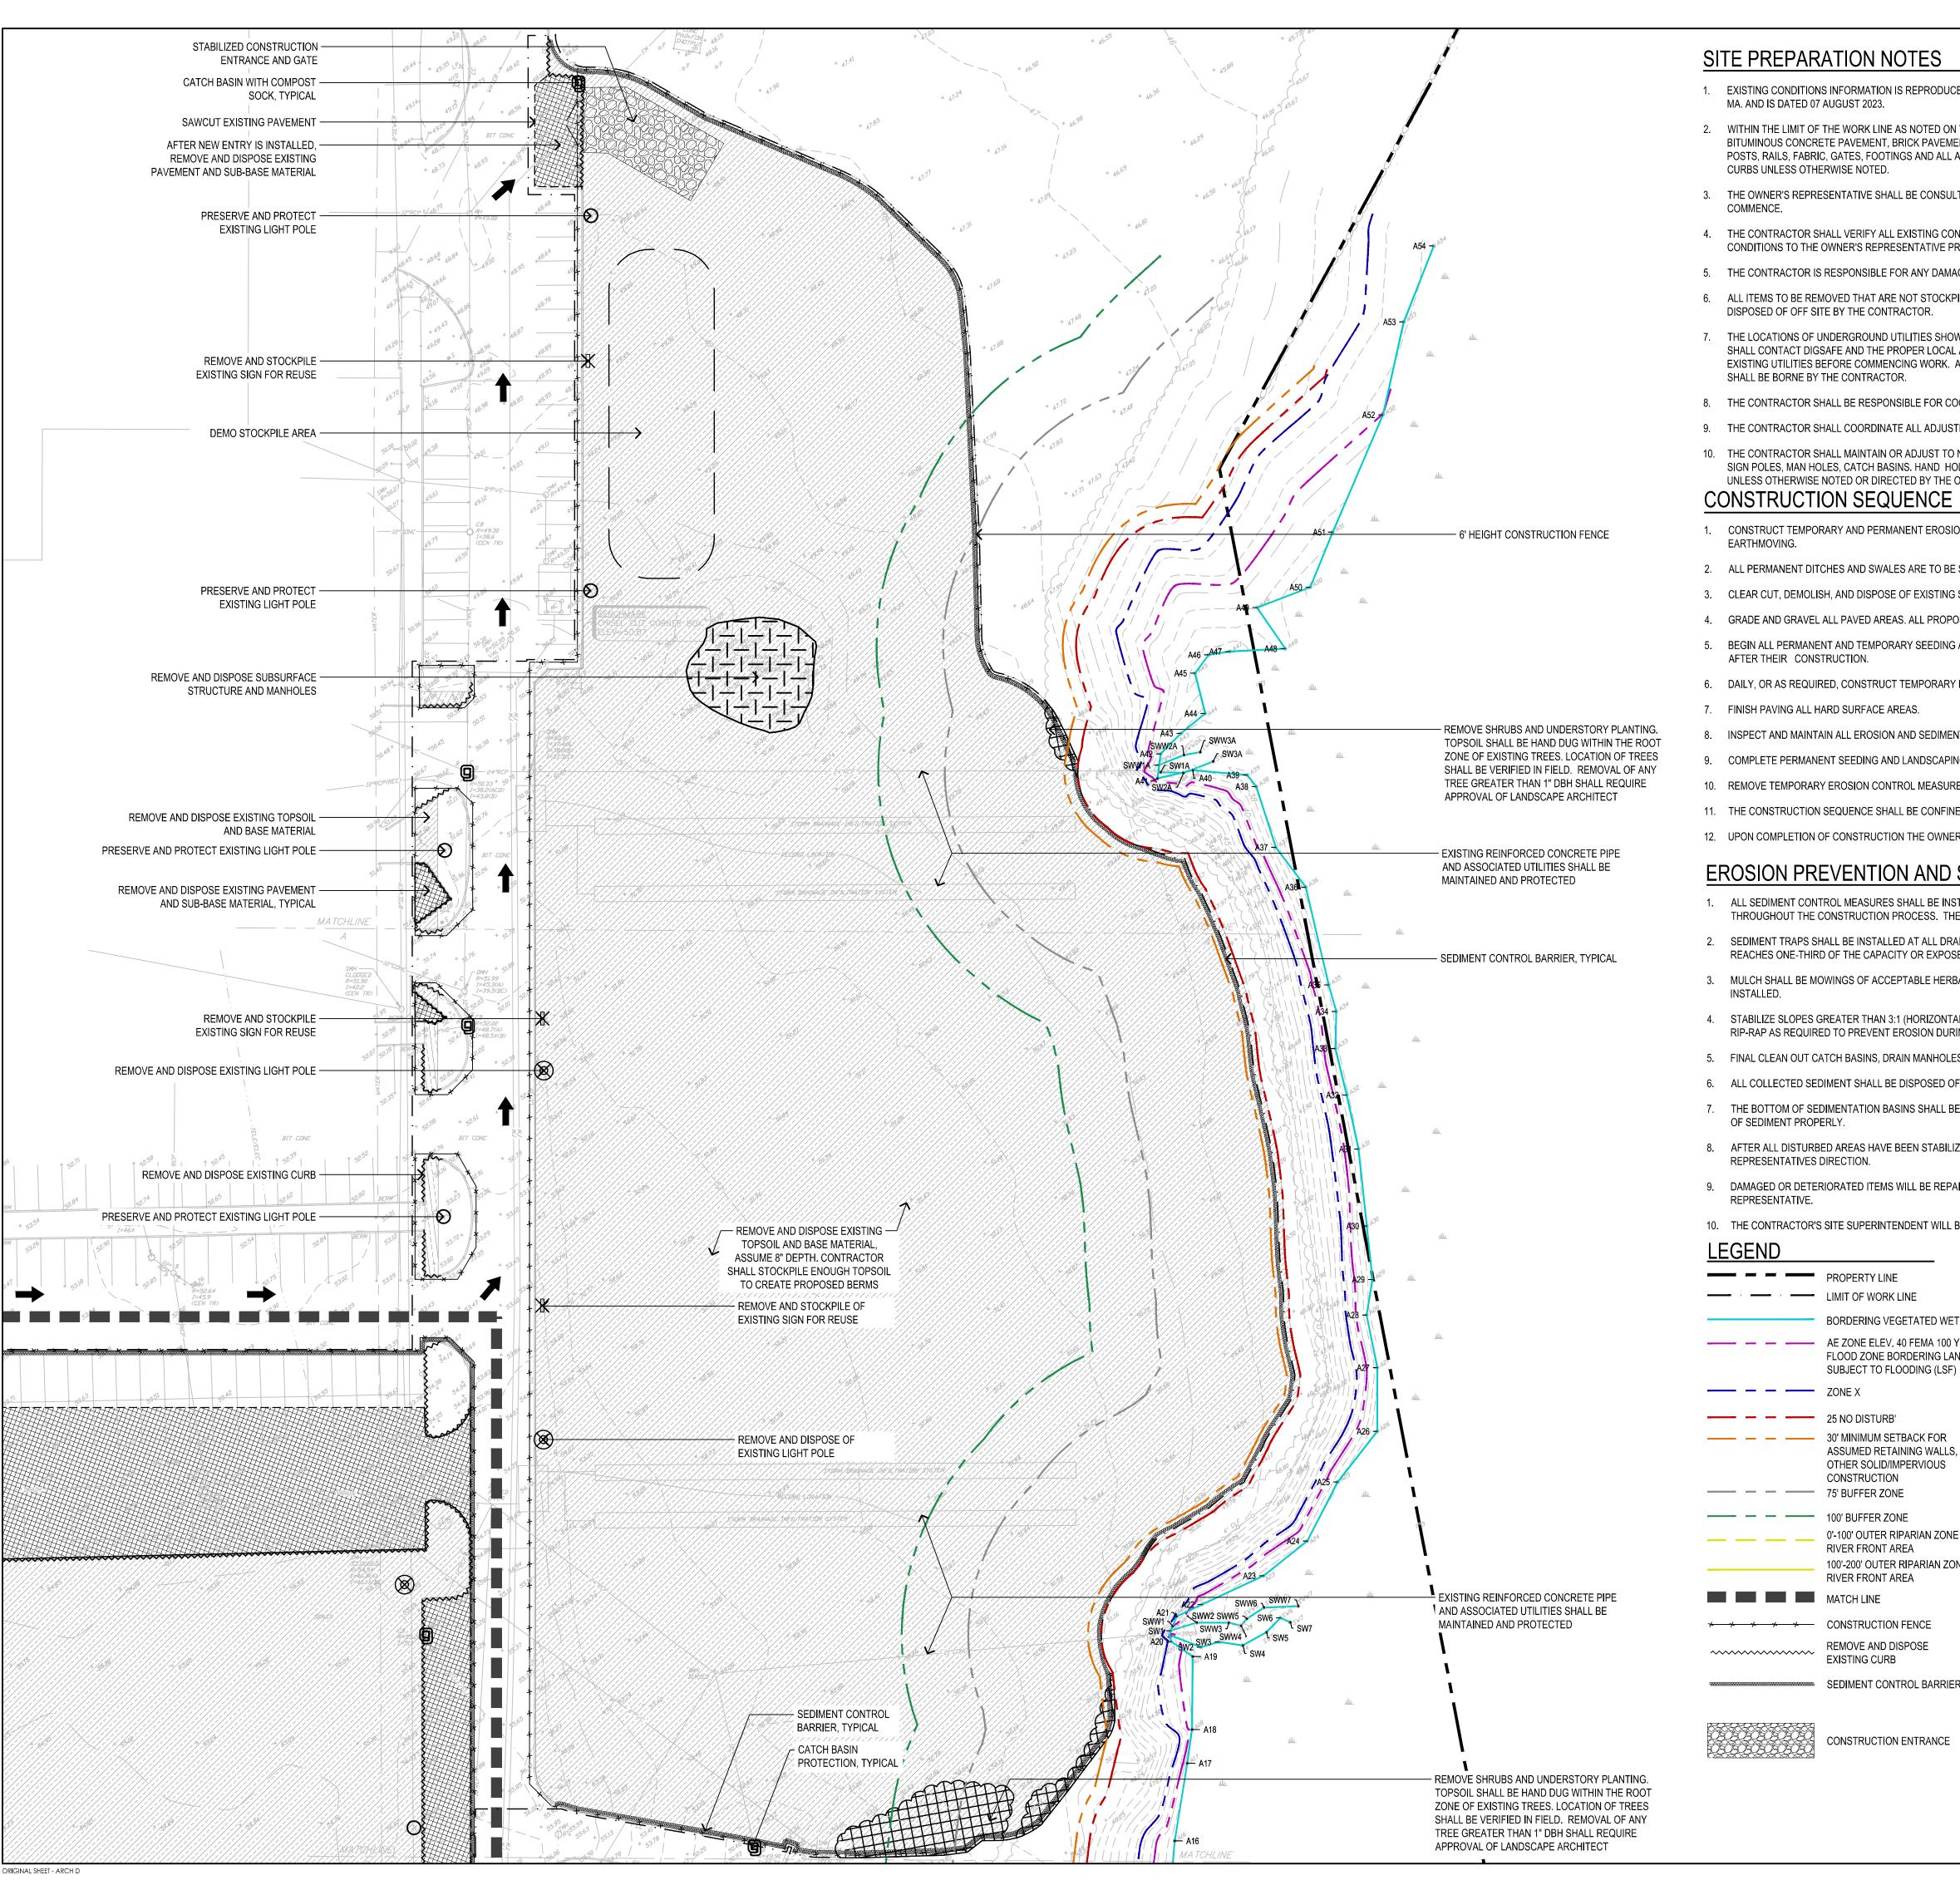
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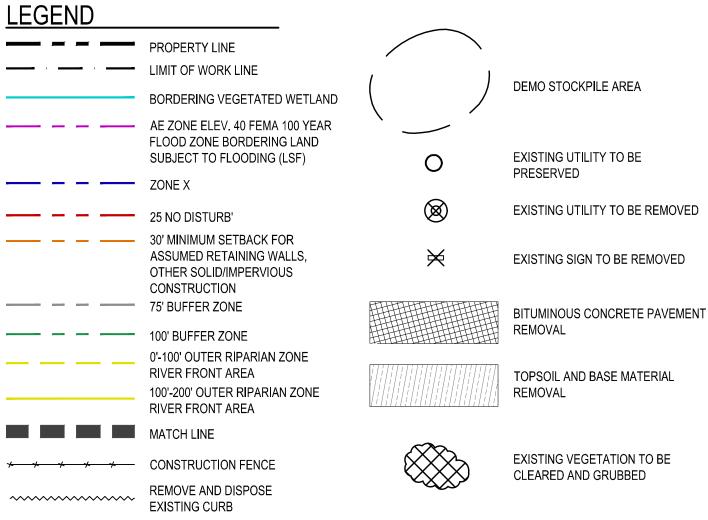
SITE PREPARATION NOTES

- 1. EXISTING CONDITIONS INFORMATION IS REPRODUCED FROM THE SURVEY PREPARED BY PRECISION LAND SURVEYING, INC. OF SOUTHBOROUGH, MA. AND IS DATED 07 AUGUST 2023.
- WITHIN THE LIMIT OF THE WORK LINE AS NOTED ON THE SITE PREPARATION PLANS, REMOVE AND DISCARD ALL CONCRETE PAVEMENT, BITUMINOUS CONCRETE PAVEMENT, BRICK PAVEMENT, TOP SOIL, MULCH, TRASH, DEAD TREES AND STUMPS, SHRUBBERY, CHAIN LINK FENCE POSTS, RAILS, FABRIC, GATES, FOOTINGS AND ALL APPURTENANCES, BOLLARDS, POSTS, CONCRETE FOOTINGS AND FOUNDATIONS, WALLS AND
- 3. THE OWNER'S REPRESENTATIVE SHALL BE CONSULTED AND WILL REVIEW THE WORK ON SITE WITH THE CONTRACTOR BEFORE ANY WORK SHALL
- 4. THE CONTRACTOR SHALL VERIFY ALL EXISTING CONDITIONS IN THE FIELD AND REPORT ANY DISCREPANCIES BETWEEN PLANS AND ACTUAL CONDITIONS TO THE OWNER'S REPRESENTATIVE PRIOR TO STARTING WORK.
- 5. THE CONTRACTOR IS RESPONSIBLE FOR ANY DAMAGE TO EXISTING CONDITIONS TO REMAIN THAT ARE DUE TO CONTRACTOR OPERATIONS.
- 6. ALL ITEMS TO BE REMOVED THAT ARE NOT STOCKPILED FOR LATER REUSE ON THE PROJECT OR DELIVERED TO THE OWNER SHALL BE LEGALLY DISPOSED OF OFF SITE BY THE CONTRACTOR.
- 7. THE LOCATIONS OF UNDERGROUND UTILITIES SHOWN ON THIS PLAN ARE BASED ON THE SURVEY REFERENCED ABOVE. THE CONTRACTOR SHALL CONTACT DIGSAFE AND THE PROPER LOCAL AUTHORITIES OR RESPECTIVE UTILITY COMPANIES TO CONFIRM THE LOCATION OF ALL EXISTING UTILITIES BEFORE COMMENCING WORK. ANY DAMAGE DUE TO FAILURE OF THE CONTRACTOR TO CONTACT THE PROPER AUTHORITIES SHALL BE BORNE BY THE CONTRACTOR.
- 8. THE CONTRACTOR SHALL BE RESPONSIBLE FOR COORDINATING HIS EFFORTS OF THE DEMOLITION WITH ALL TRADES.
- 9. THE CONTRACTOR SHALL COORDINATE ALL ADJUSTMENT OR ABANDONMENT OF UTILITIES WITH THE RESPECTIVE UTILITY COMPANY.
- 10. THE CONTRACTOR SHALL MAINTAIN OR ADJUST TO NEW FINISH GRADE AS NECESSARY ALL UTILITY AND SITE STRUCTURES SUCH AS LIGHT POLES, SIGN POLES, MAN HOLES, CATCH BASINS. HAND HOLES, WATER AND GAS GATES, HYDRANTS, ETC., FROM MAINTAINED UTILITY AND SITE SYSTEMS UNLESS OTHERWISE NOTED OR DIRECTED BY THE OWNER'S REPRESENTATIVE.

- 1. CONSTRUCT TEMPORARY AND PERMANENT EROSION CONTROL FACILITIES. EROSION CONTROL FACILITIES SHALL BE INSTALLED PRIOR TO ANY
- 2. ALL PERMANENT DITCHES AND SWALES ARE TO BE STABILIZED WITH VEGETATION OR RIP-RAP PRIOR TO DIRECTING RUNOFF TO THEM.
- 3. CLEAR CUT, DEMOLISH, AND DISPOSE OF EXISTING SITE ELEMENTS NOT TO REMAIN.
- 4. GRADE AND GRAVEL ALL PAVED AREAS. ALL PROPOSED PAVED AREAS SHALL BE STABILIZED IMMEDIATELY AFTER GRADING.
- 5. BEGIN ALL PERMANENT AND TEMPORARY SEEDING AND MULCHING. ALL CUT AND FILL SLOPES SHALL BE SEEDED AND MULCHED IMMEDIATELY
- 6. DAILY, OR AS REQUIRED, CONSTRUCT TEMPORARY BERMS, DRAINS, DITCHES, SILT FENCES; MULCH AND SEED AS REQUIRED.
- 8. INSPECT AND MAINTAIN ALL EROSION AND SEDIMENT CONTROL MEASURES.
- 9. COMPLETE PERMANENT SEEDING AND LANDSCAPING.
- 10. REMOVE TEMPORARY EROSION CONTROL MEASURES.
- 11. THE CONSTRUCTION SEQUENCE SHALL BE CONFINED TO THE LIMIT OF GRADING AS SHOWN ON THE DRAWINGS.
- 12. UPON COMPLETION OF CONSTRUCTION THE OWNER SHALL AGREE TO MAINTAIN AND CLEAN ALL DRAINAGE STRUCTURES ON A YEARLY BASIS.

EROSION PREVENTION AND SEDIMENT CONTROL MEASURES

- 1. ALL SEDIMENT CONTROL MEASURES SHALL BE INSTALLED PRIOR TO ANY SITE EXCAVATION OR DISTURBANCE AND SHALL BE MAINTAINED THROUGHOUT THE CONSTRUCTION PROCESS. THE SMALLEST PRACTICAL AREA OF LAND SHALL BE EXPOSED AT ANY ONE TIME.
- 2. SEDIMENT TRAPS SHALL BE INSTALLED AT ALL DRAINAGE STRUCTURES. SEDIMENT CONTROL DEVICES SHALL BE CLEANED OF SEDIMENT WHEN IT REACHES ONE-THIRD OF THE CAPACITY OR EXPOSED HEIGHT.
- 3. MULCH SHALL BE MOWINGS OF ACCEPTABLE HERBACEOUS GROWTH, FREE OF NOXIOUS WEEDS OR WOODY STEMS, AND SHALL BE DRY WHEN
- 4. STABILIZE SLOPES GREATER THAN 3:1 (HORIZONTAL: VERTICAL) WITH SEED, SECURED GEOTEXTILE FABRIC, SPRAYED COMPOST BLANKET, OR RIP-RAP AS REQUIRED TO PREVENT EROSION DURING CONSTRUCTION.
- 5. FINAL CLEAN OUT CATCH BASINS, DRAIN MANHOLES, STORM DRAIN PIPES, AND DETENTION BASINS AFTER COMPLETION OF CONSTRUCTION.
- 6. ALL COLLECTED SEDIMENT SHALL BE DISPOSED OF PROPERLY TO AN APPROVED LOCATION.
- 7. THE BOTTOM OF SEDIMENTATION BASINS SHALL BE PERIODICALLY CLEANED PER THE DIRECTION OF THE OWNER'S REPRESENTATIVE. DISPOSE
- 8. AFTER ALL DISTURBED AREAS HAVE BEEN STABILIZED, CONTRACTOR TO REMOVE ALL TEMPORARY CONTROL MEASURES AT THE OWNER'S
- 9. DAMAGED OR DETERIORATED ITEMS WILL BE REPAIRED IMMEDIATELY AFTER IDENTIFICATION OR AS DIRECTED BY THE OWNER'S
- 10. THE CONTRACTOR'S SITE SUPERINTENDENT WILL BE RESPONSIBLE FOR DAILY INSPECTIONS, MAINTENANCE, AND REPAIR ACTIVITIES.



CONSTRUCTION ACCESS

CATCH BASIN PROTECTION



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Locus Map

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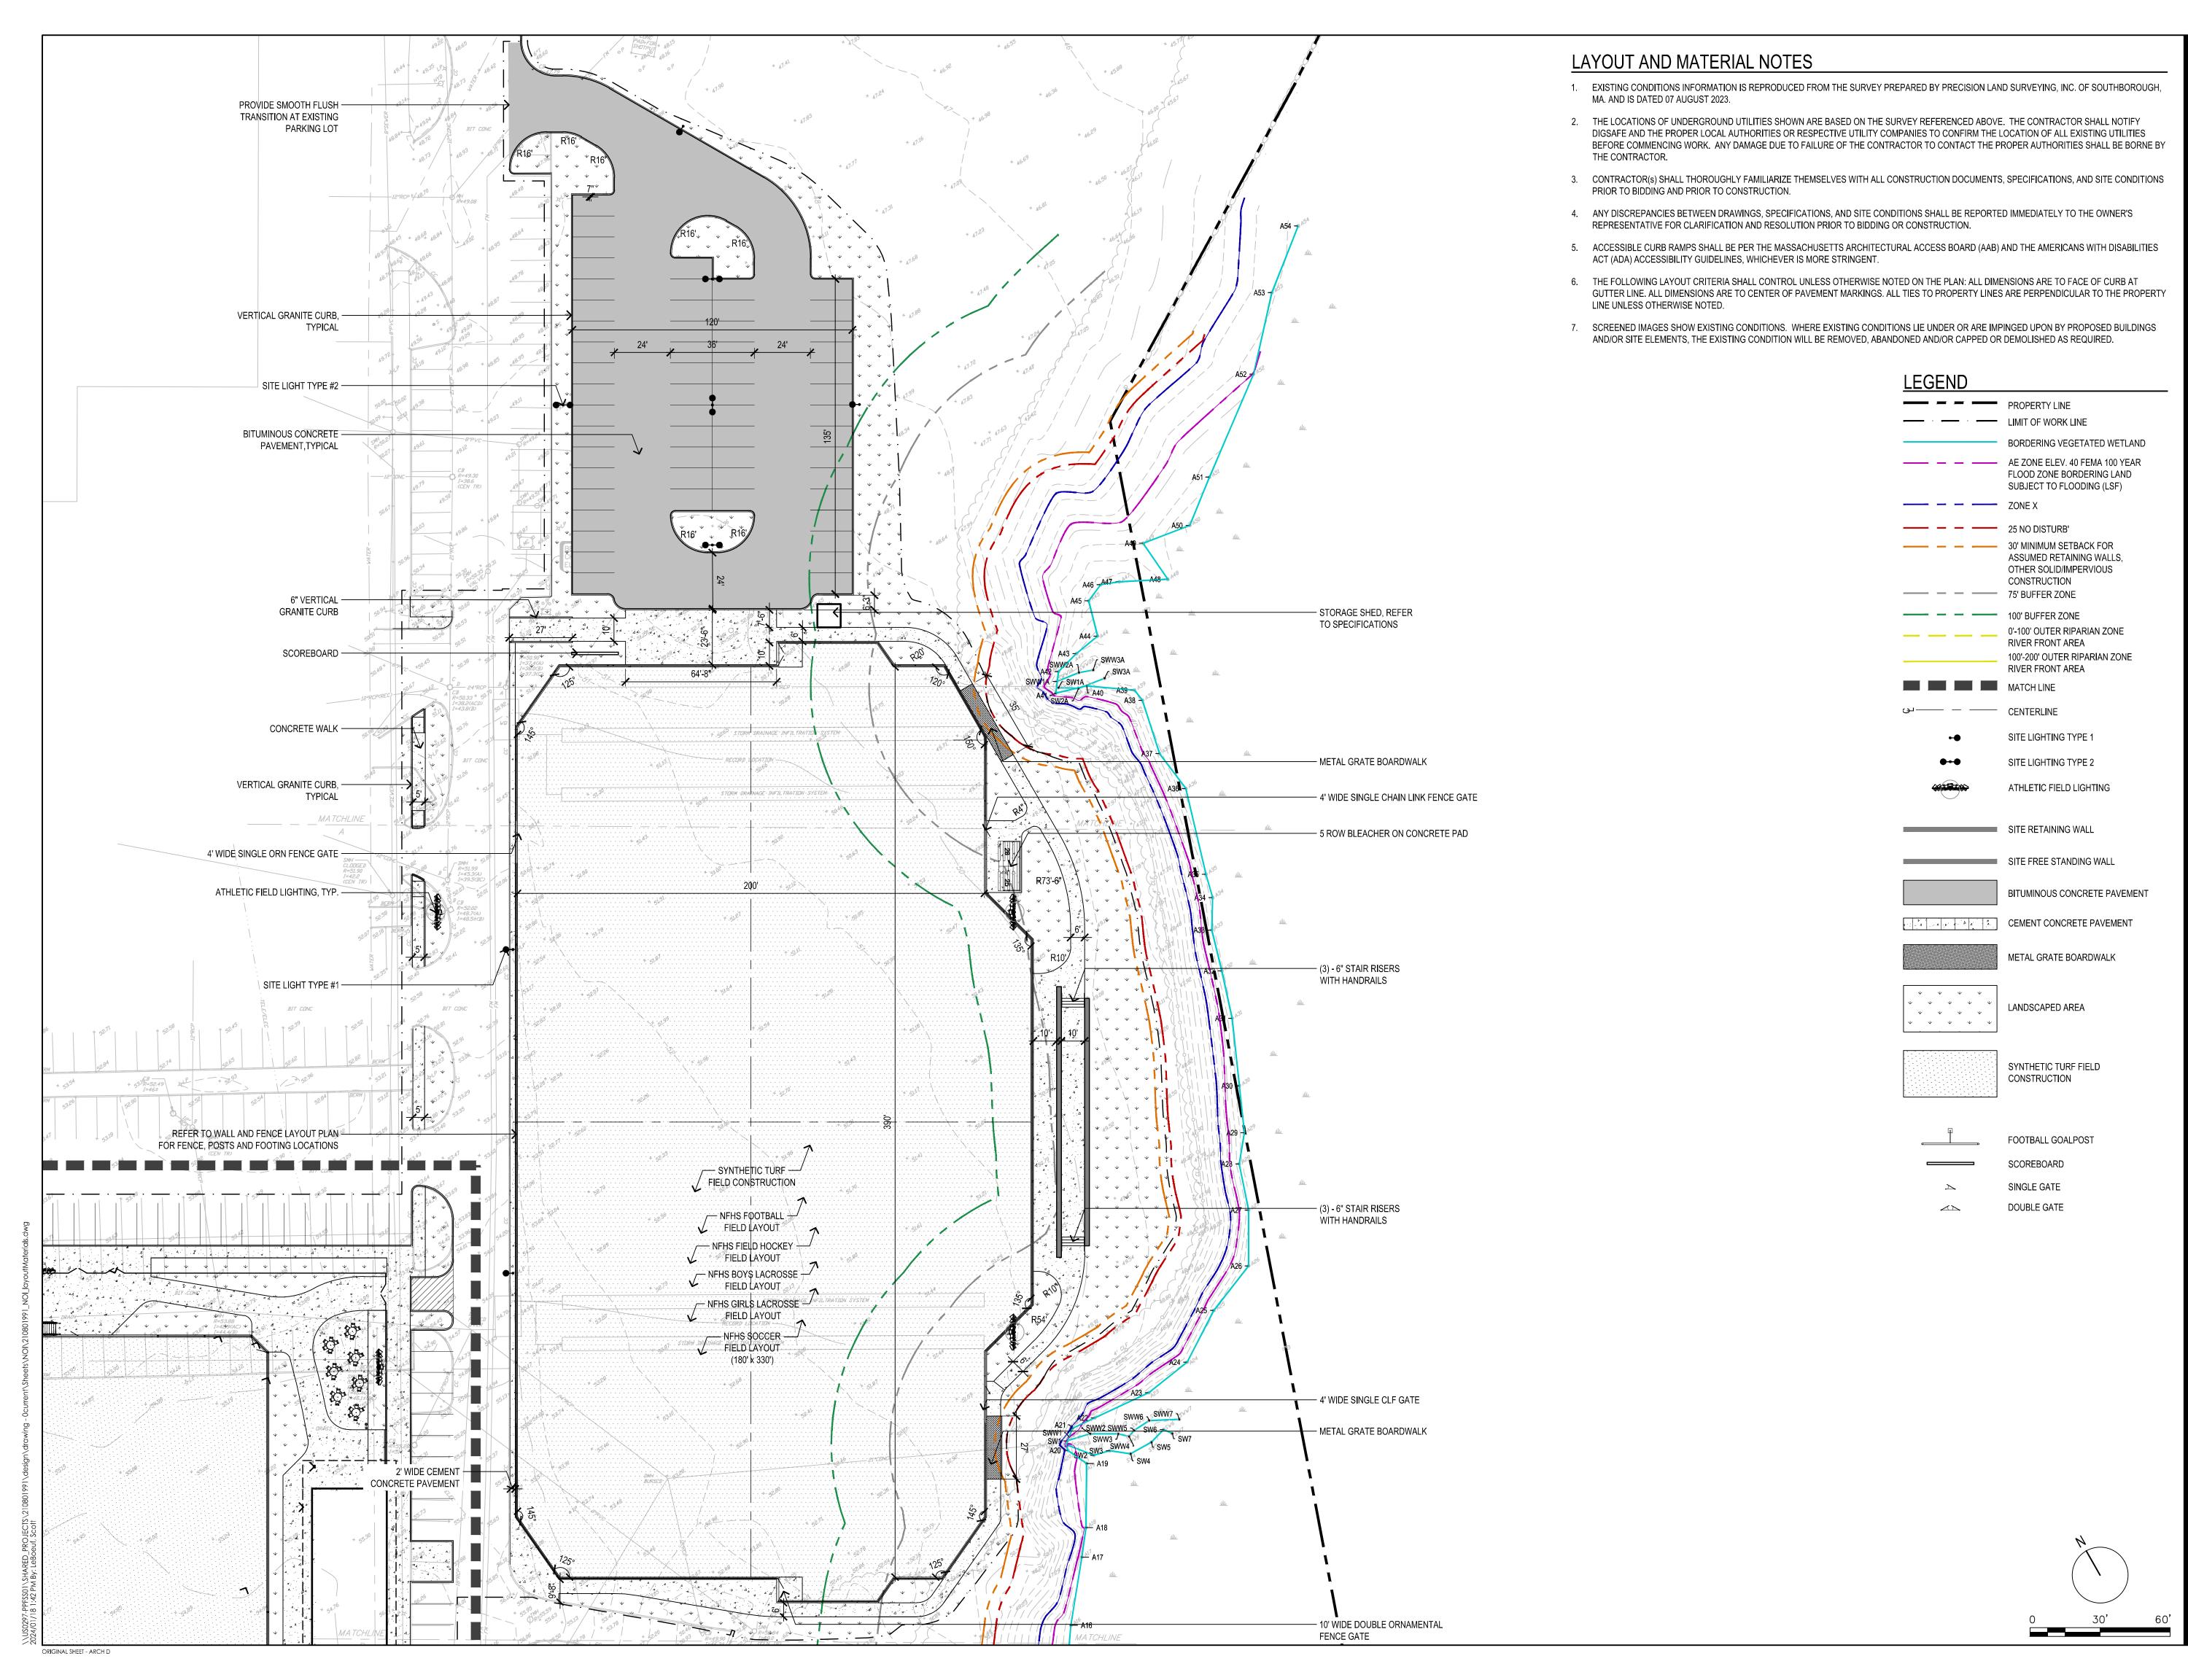
Client/Project

MASCONOMET REGIONAL SCHOOL DISTRICT

SYNTHETIC TURF FIELDS NOTICE OF INTENT BOXFORD, MA

Project No.: 210801991 Scale: AS NOTED

SITE PREPARATION PLAN





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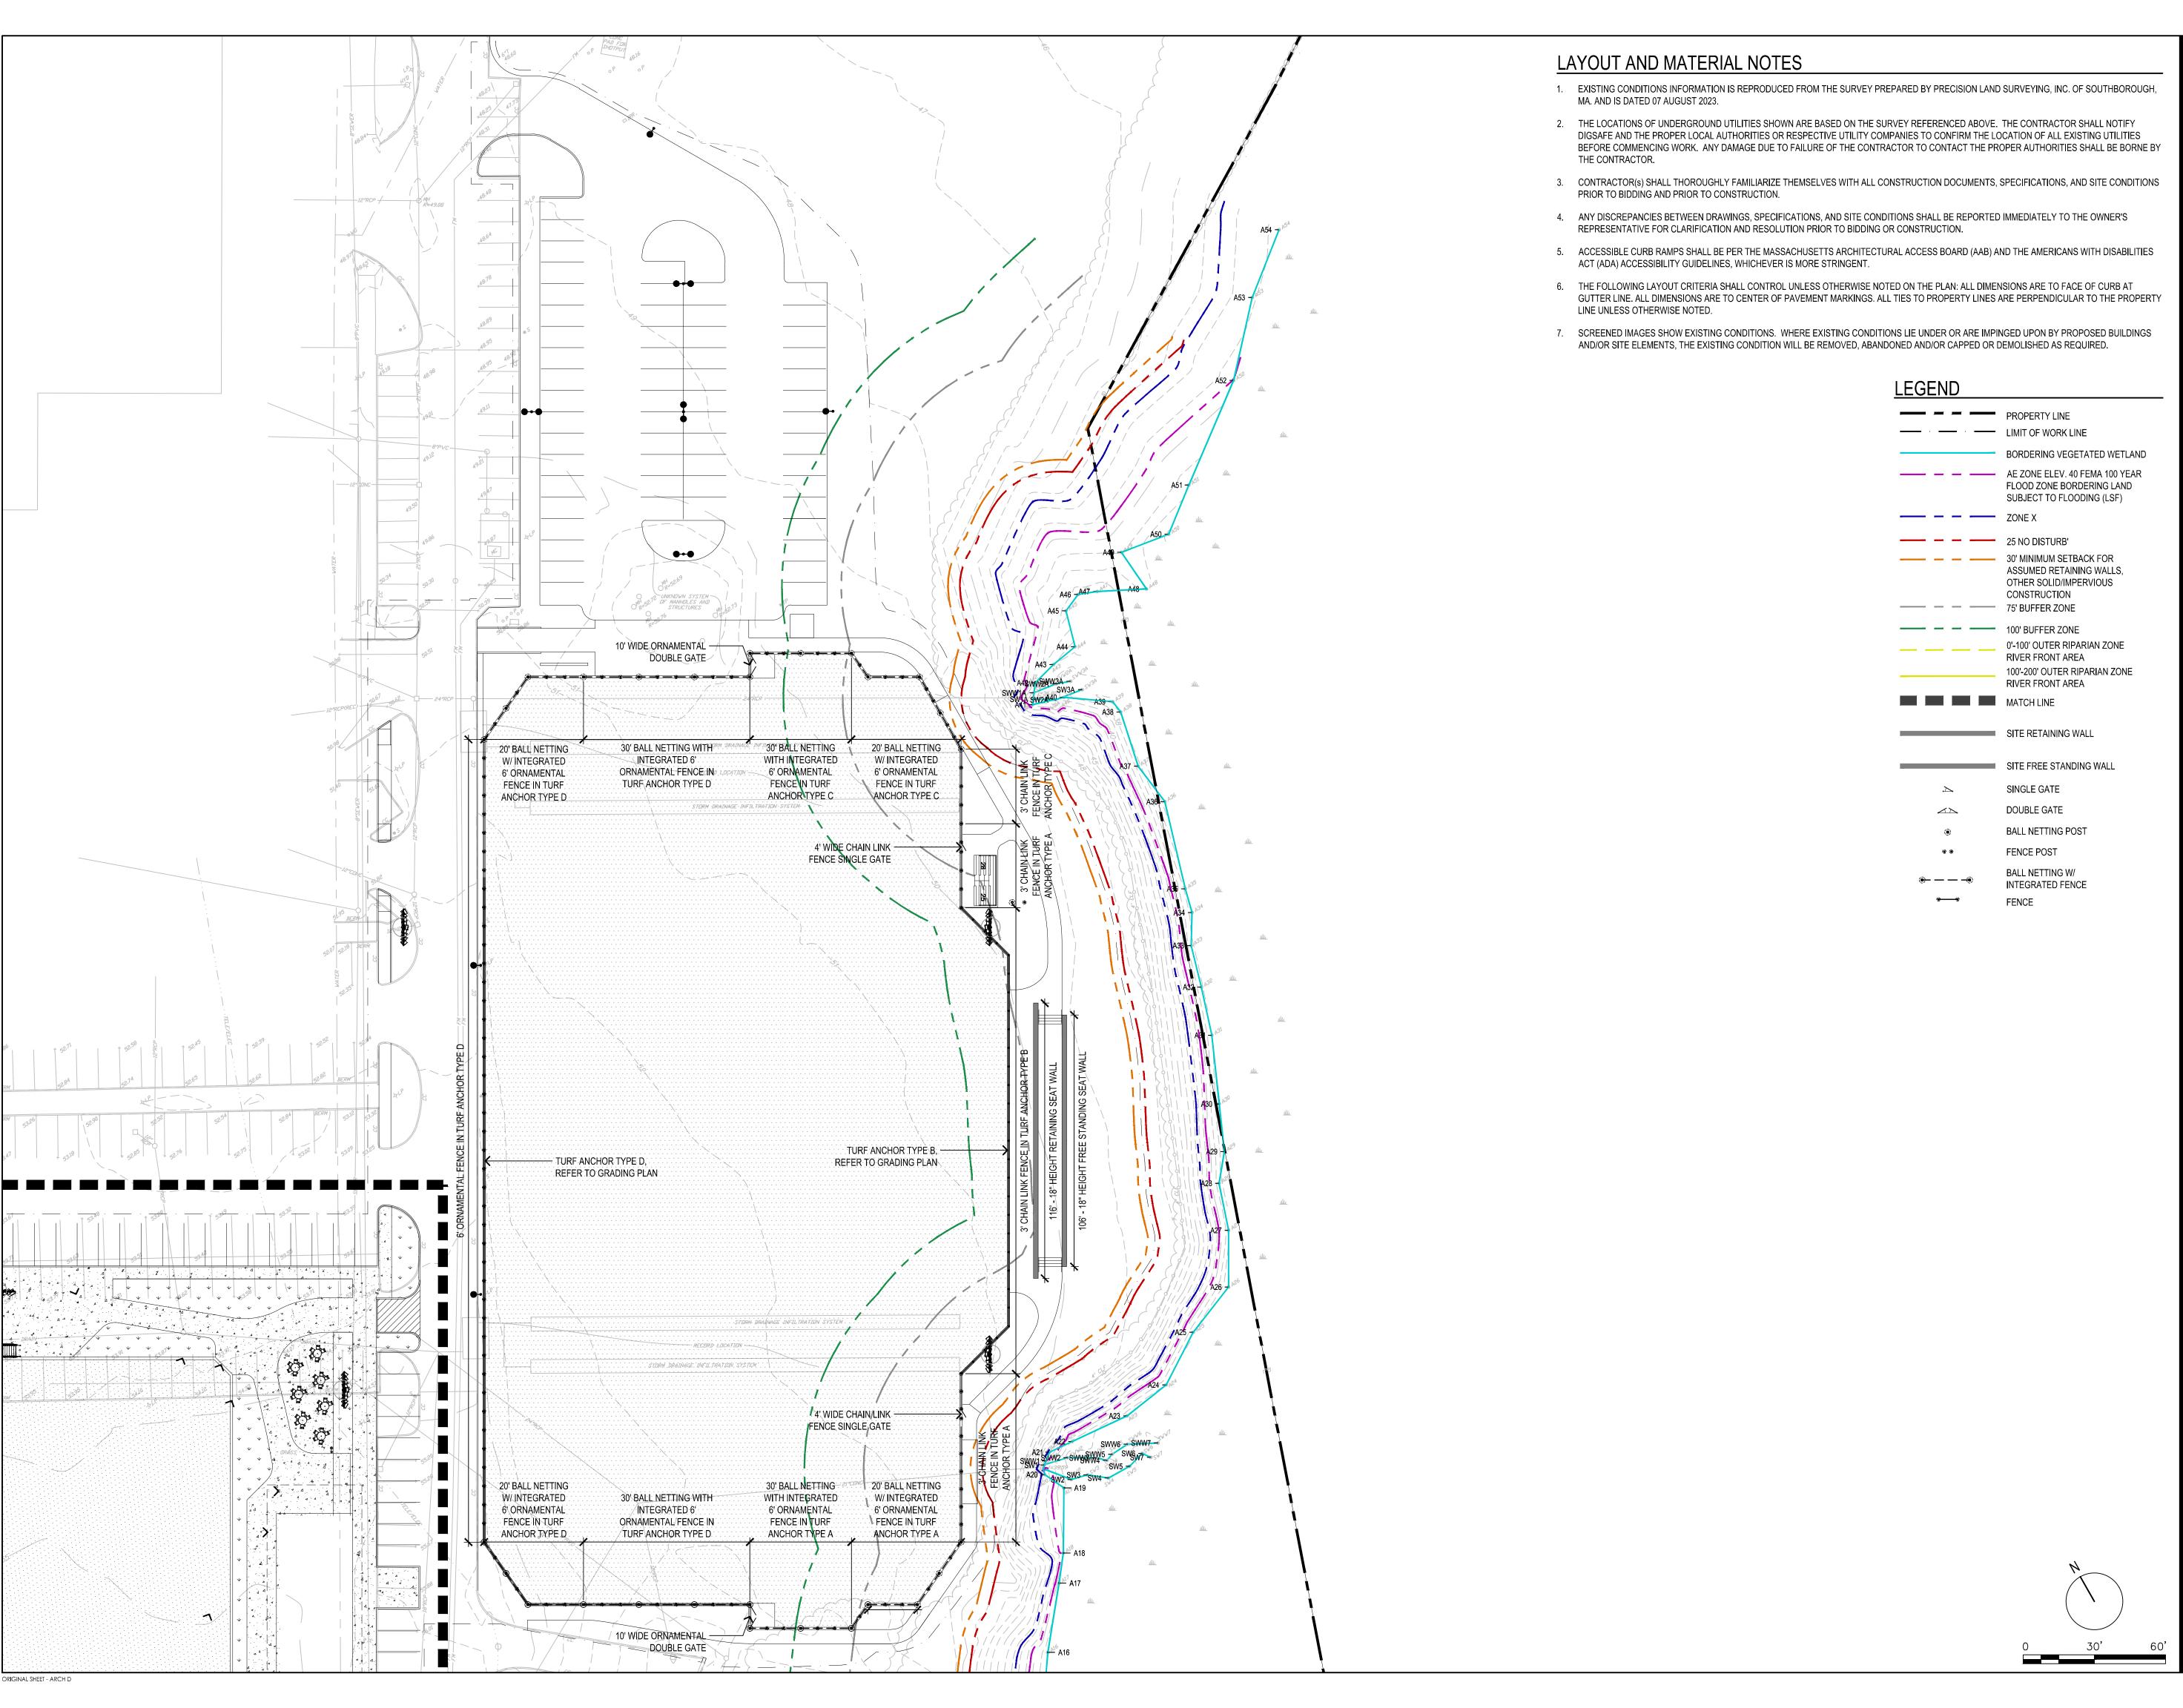
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SYNTHETIC TURF FIELDS
NOTICE OF INTENT
BOXFORD, MA

Project No.: 210801991 Scale: AS NOTED

LAYOUT AND MATERIALS
PLAN

Drawing No.





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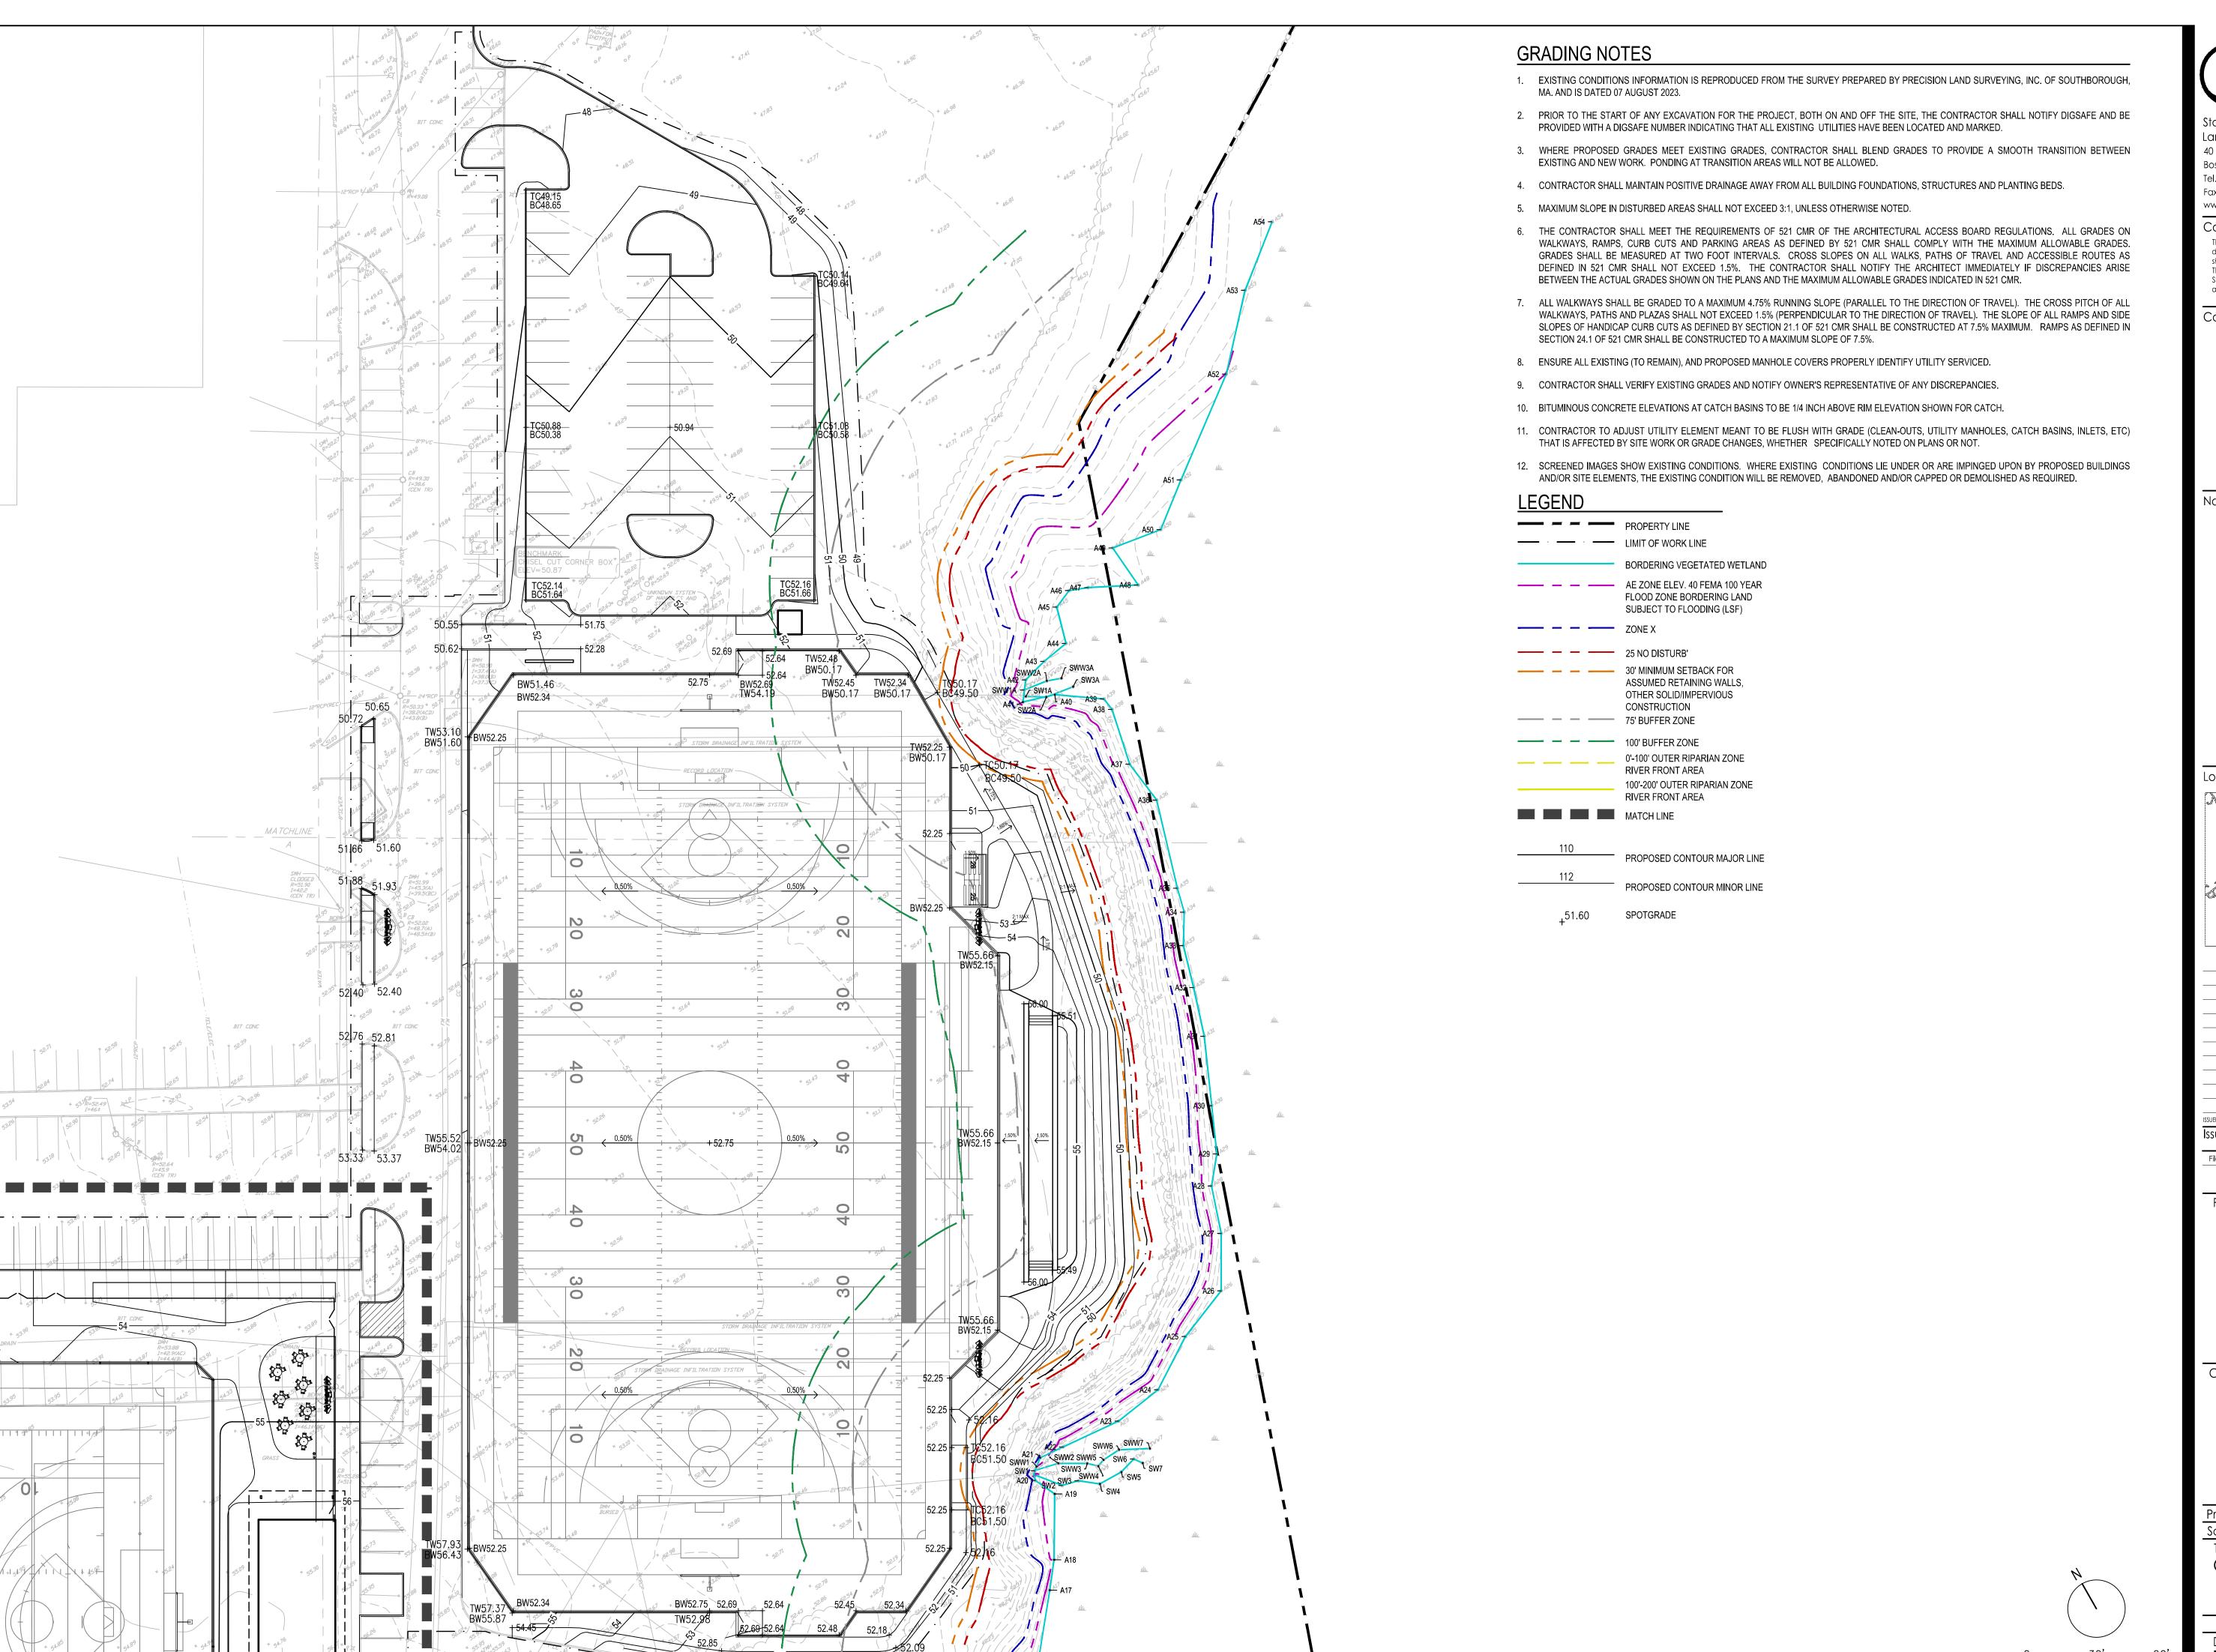
MASCONOMET REGIONAL SCHOOL DISTRICT

SYNTHETIC TURF FIELDS NOTICE OF INTENT BOXFORD, MA

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Title
WALL AND FENCE LAYOUT

Drawing No.





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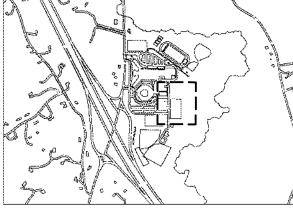
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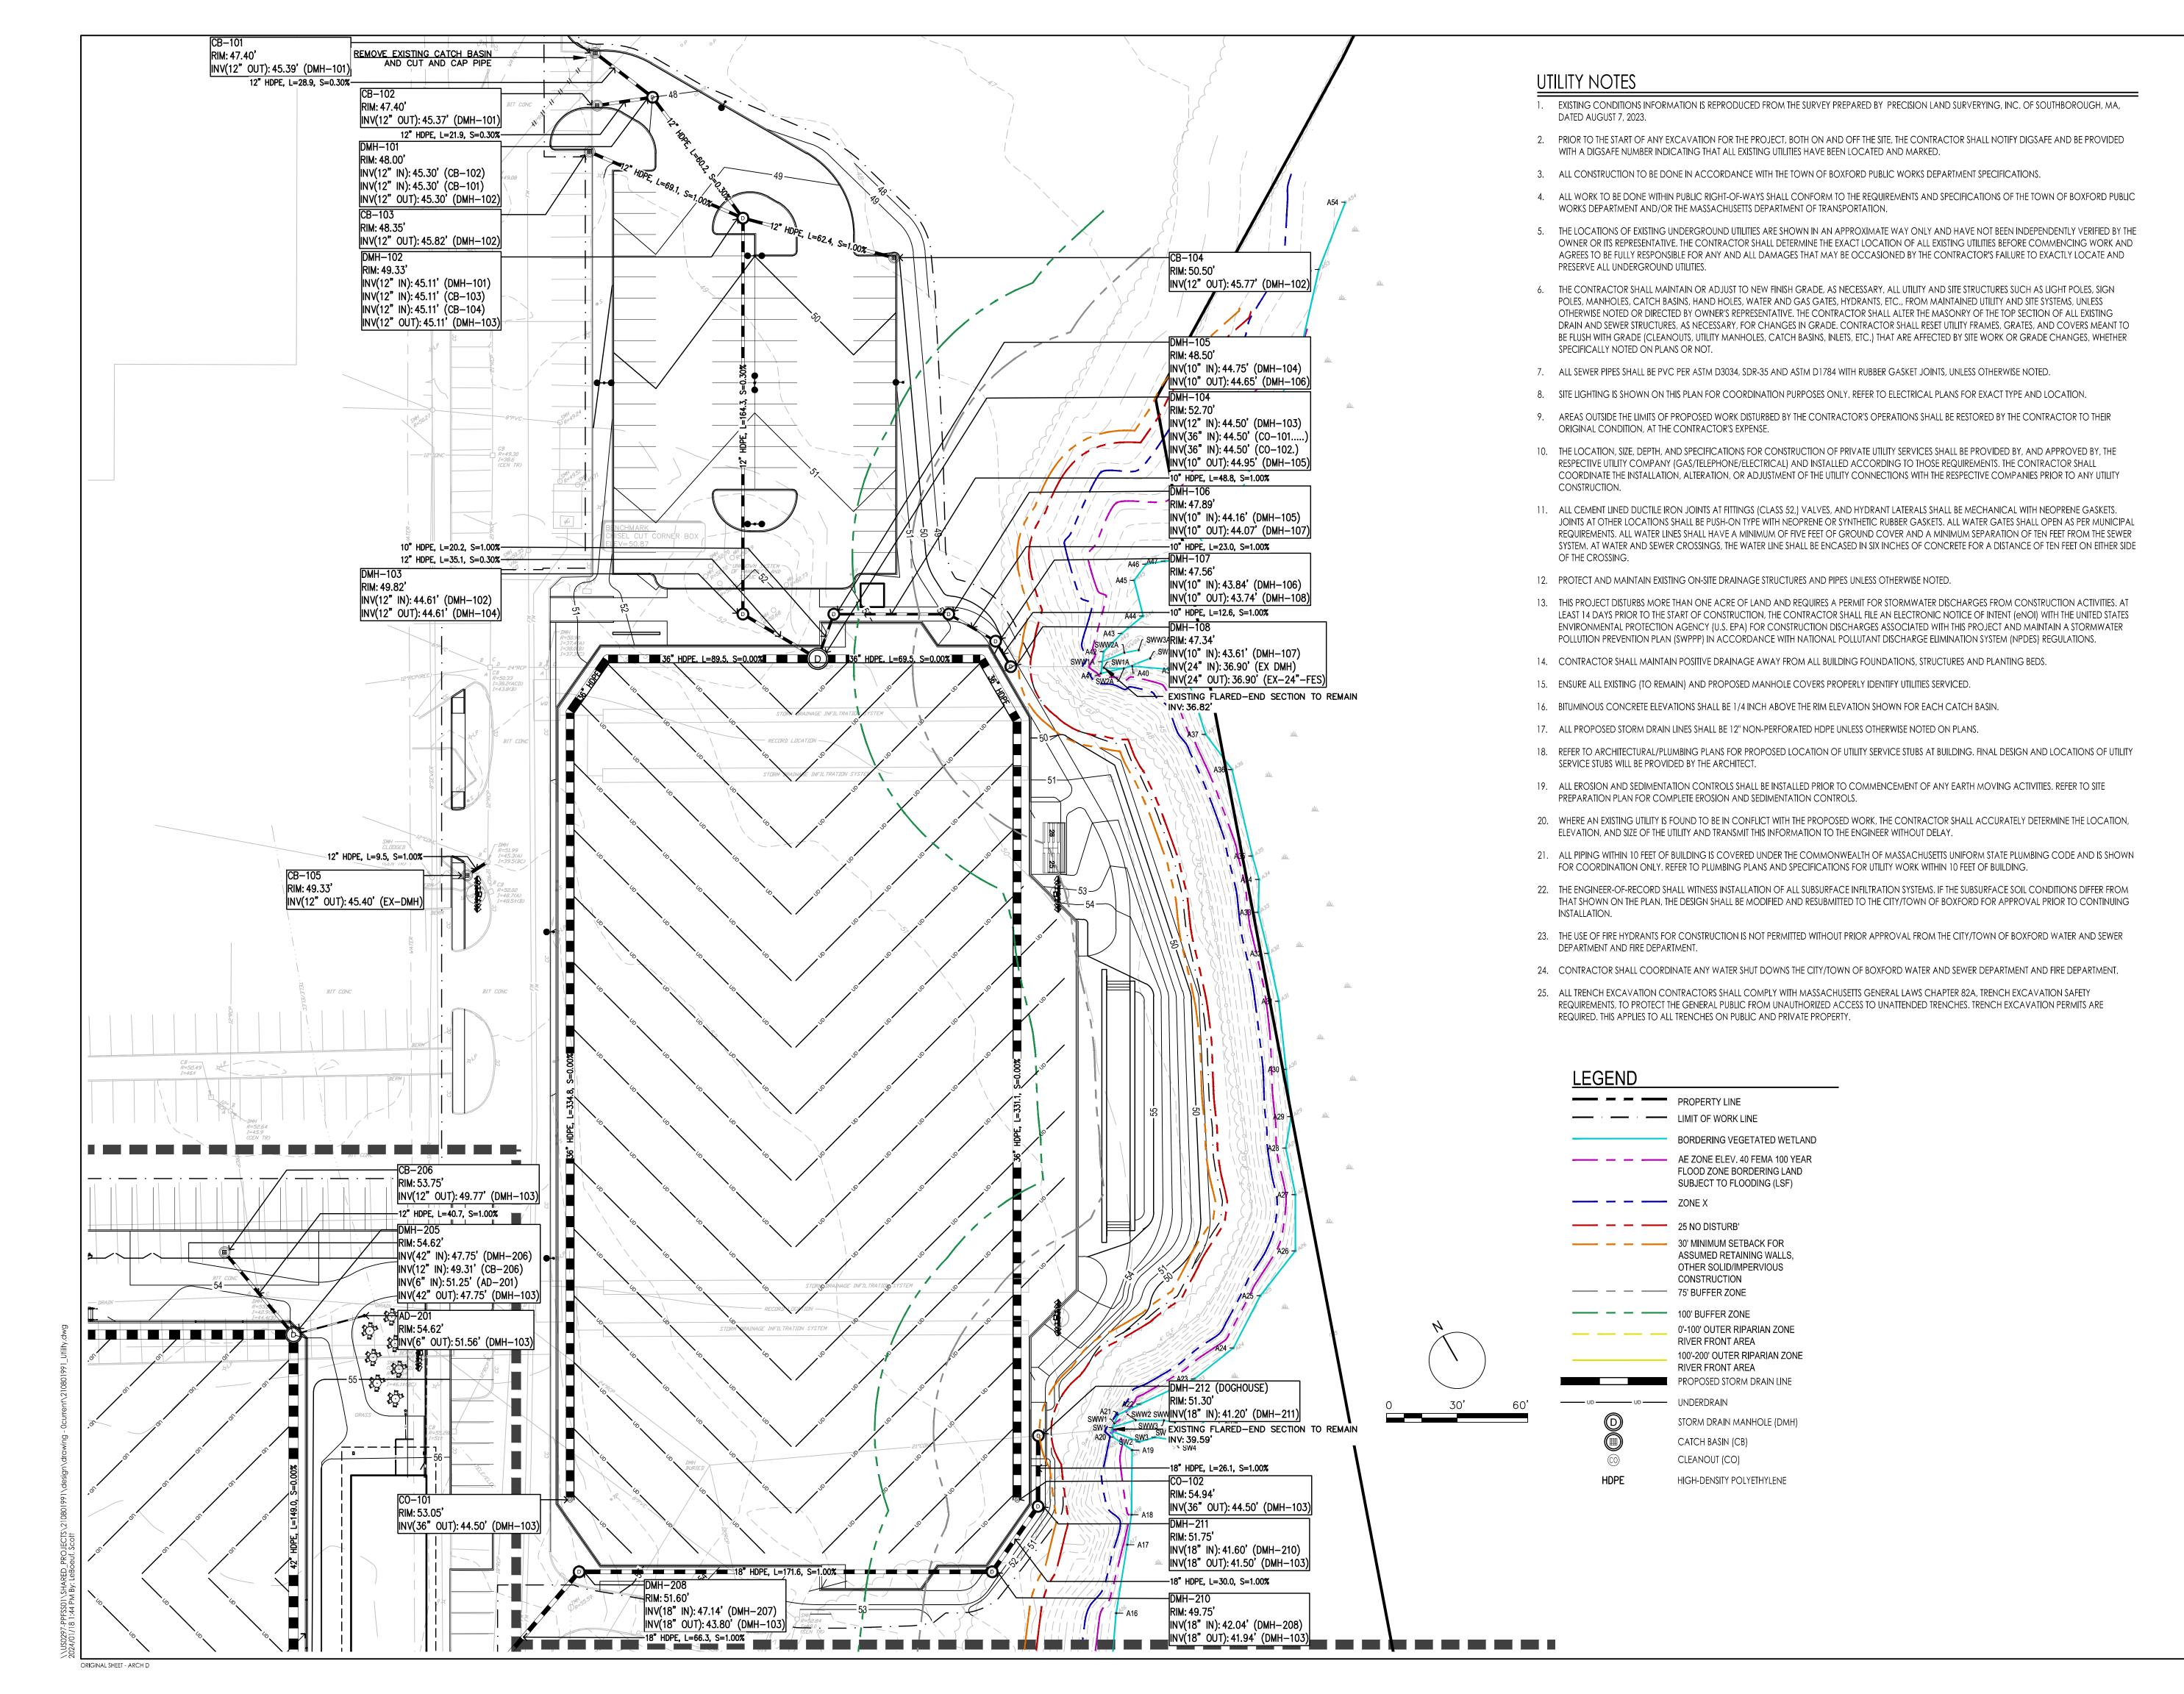
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Project No.: 210801991 Scale: AS NOTED

Title GRADING PLAN

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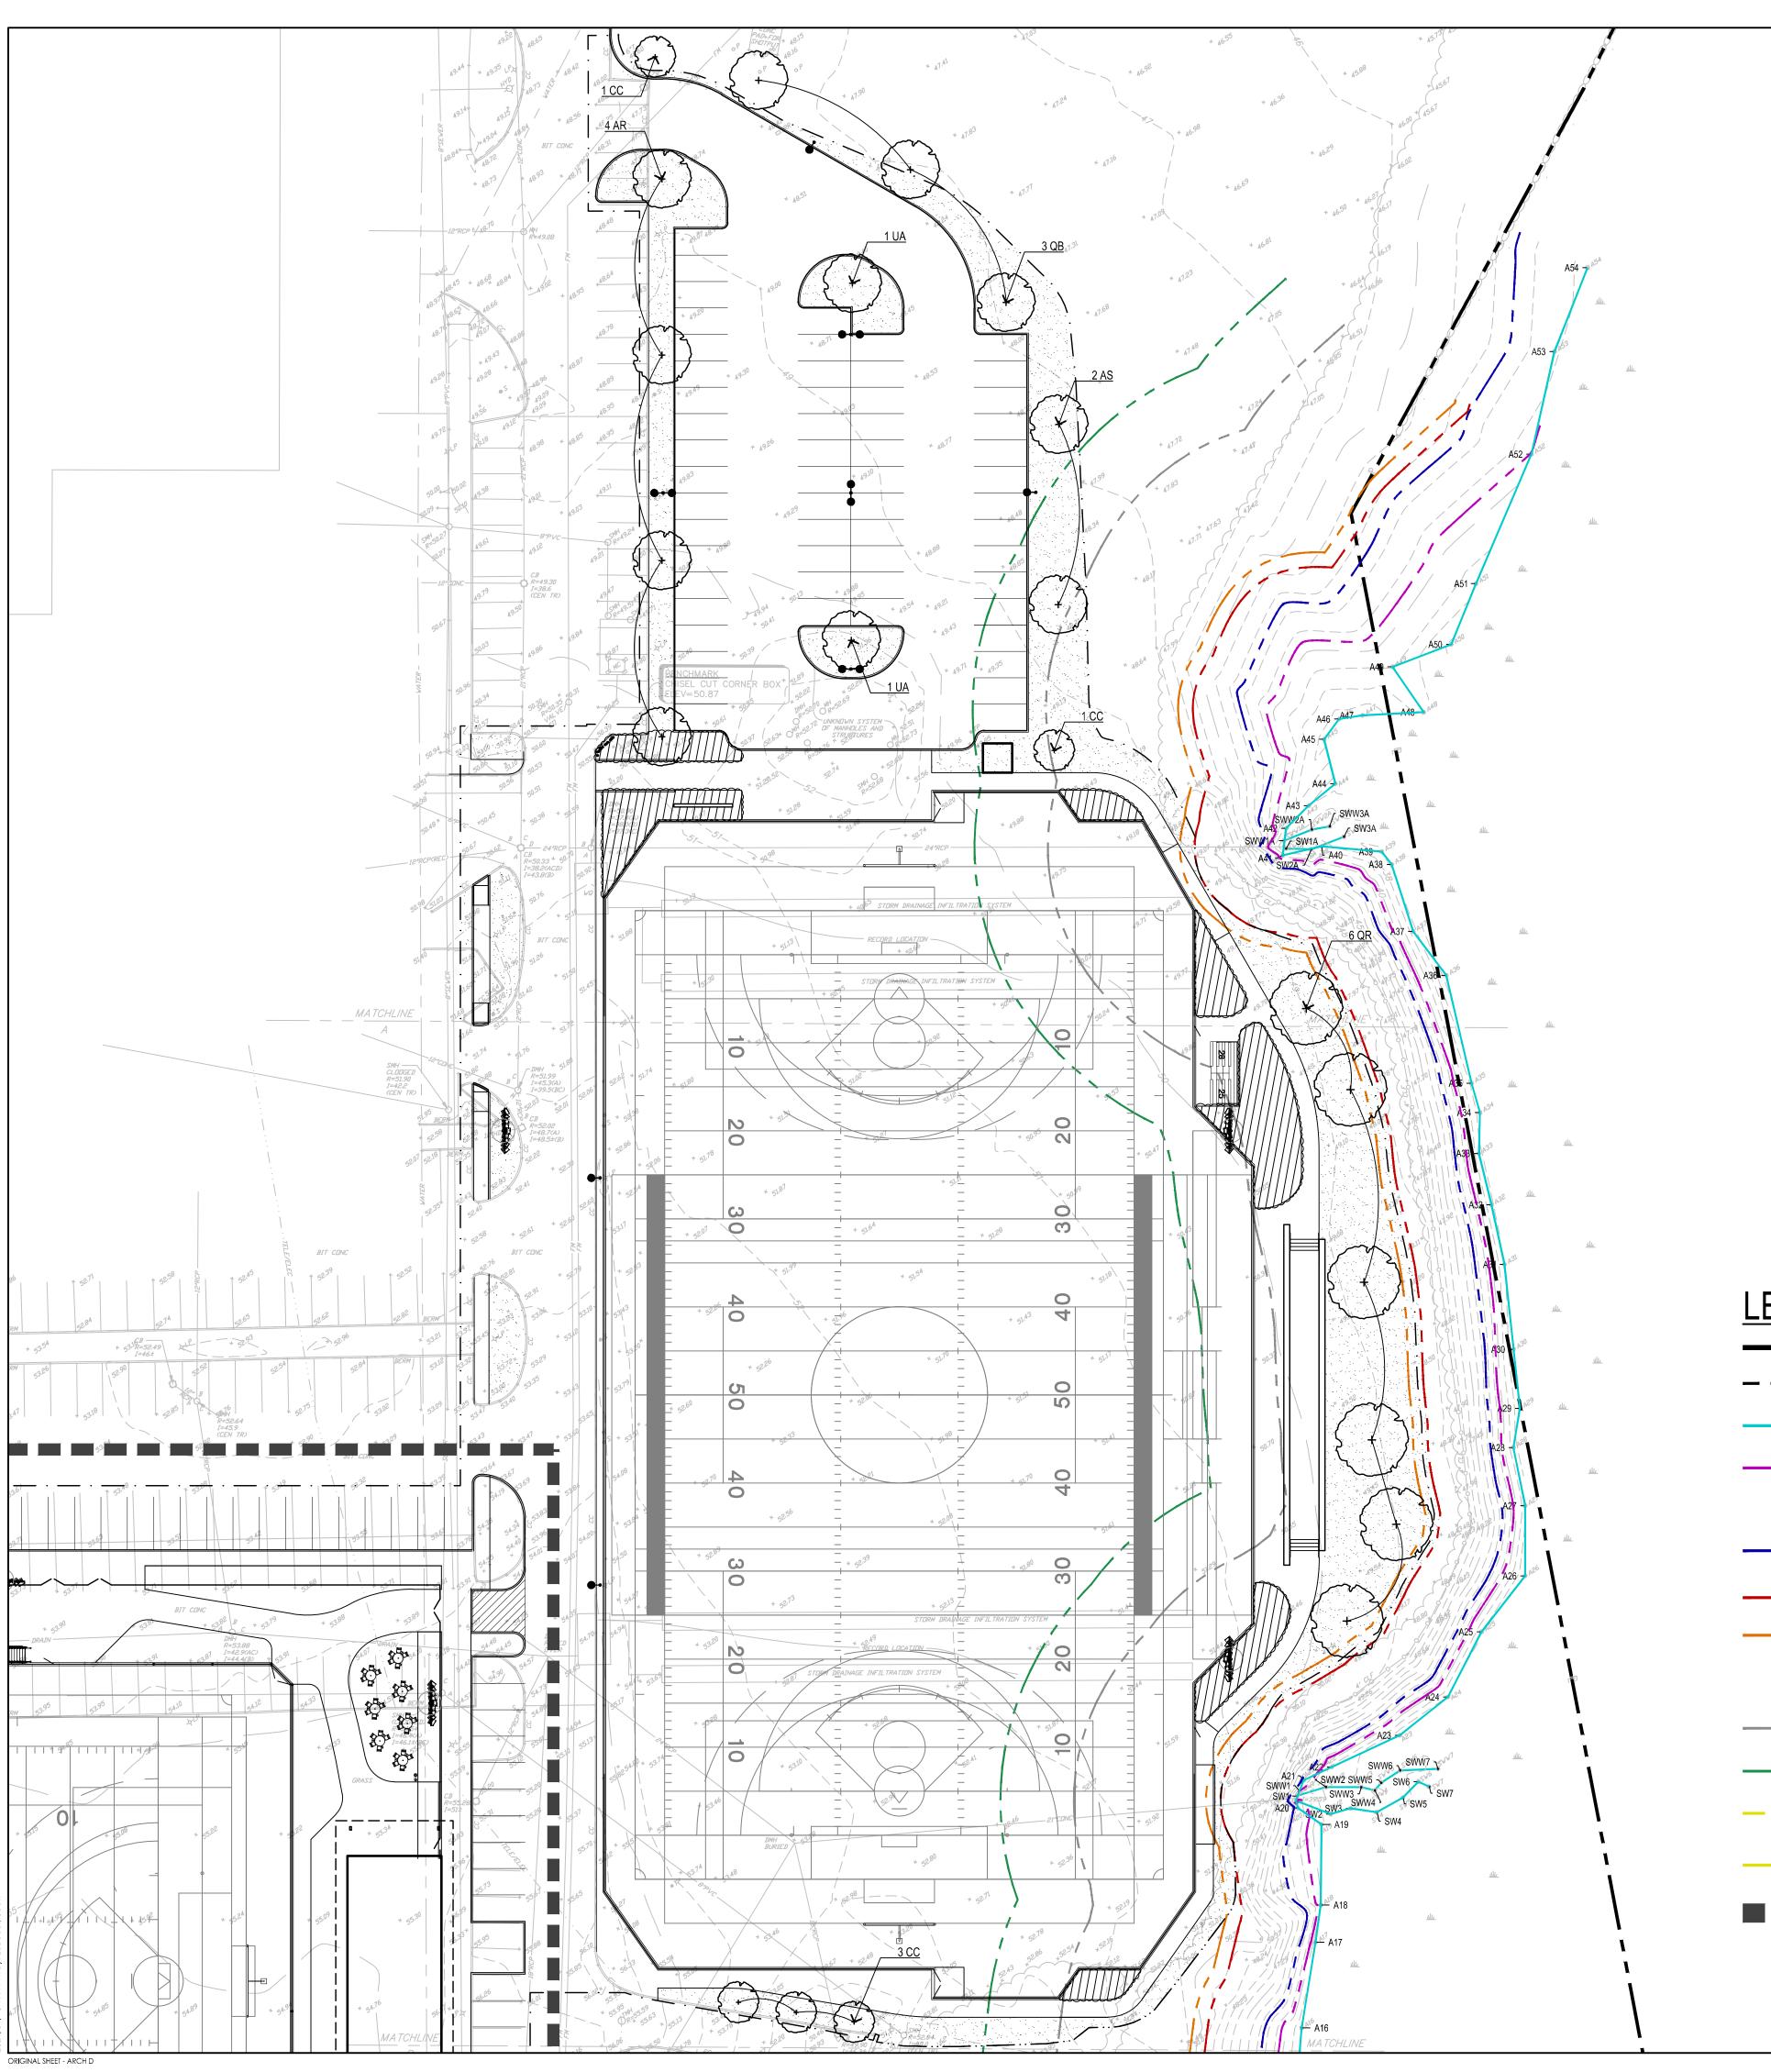
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DRAINAGE AND GRADING PLAN

Orawing No.



PLANTING NOTES

- 1. CONTRACTOR SHALL BEGIN MAINTENANCE IMMEDIATELY AFTER PLANTING AND WILL CONTINUE UNTIL FINAL WRITTEN ACCEPTANCE OF PLANT MATERIAL.
- 2. CONTRACTOR SHALL VERIFY ALL TREE REMOVALS AND/OR TRANSPLANTS WITH OWNER'S REPRESENTATIVE PRIOR TO CONSTRUCTION START.
- 3. CONTRACTOR SHALL MAINTAIN POSITIVE DRAINAGE AWAY FROM ALL BUILDING FOUNDATIONS, STRUCTURES, AND PLANTING BEDS.
- 4. MAXIMUM SLOPE WITHIN DISTURBED AREAS SHALL NOT EXCEED 3:1, UNLESS OTHERWISE NOTED.
- 5. THE LANDSCAPE CONTRACTOR SHALL SUPPLY ALL PLANT MATERIALS IN QUANTITIES SUFFICIENT TO COMPLETE ALL PLANTINGS SHOWN ON THIS DRAWING.
- 6. ALL MATERIALS SHALL CONFORM TO THE GUIDELINES ESTABLISHED BY THE AMERICAN NURSERY AND LANDSCAPE ASSOCIATION.
- 7. ALL PLANTS SHALL BEAR THE SAME RELATIONSHIP TO FINISH GRADE AS TO ORIGINAL GRADES BEFORE DIGGING.
- 8. ALL PLANTS TO BE BALLED IN BURLAP OR CONTAINERIZED.
- 9. MULCH FOR PLANTED AREAS TO BE AGED PINE BARK: PARTIALLY DECOMPOSED, DARK BROWN IN COLOR AND FREE OF WOOD CHIPS THICKER THAN 1/4 INCH.
- 10. PLANTING SOIL MIX: LOAM THOROUGHLY INCORPORATED WITH ROTTED MANURE PROPORTIONED 5 C.Y. TO 1 C.Y. OR EQUIVALENT. FERTILIZER ADDED PER RECOMMENDED RATES OF SOILS ANALYSIS.
- 11. THE LANDSCAPE CONTRACTOR SHALL GUARANTEE ALL PLANT MATERIALS FOR ONE (1) FULL YEAR FROM DATE OF ACCEPTANCE.
- 12. ALL PLANT MATERIALS ARE SUBJECT TO THE APPROVAL OF THE LANDSCAPE ARCHITECT, AT THE NURSERY, AND AT THE SITE.
- 13. ALL AREAS OF THE SITE WHICH HAVE BEEN DISTURBED AND NOT OTHERWISE DEVELOPED SHALL BE LOAMED AND SEEDED WITH A MINIMUM DEPTH OF 6" DEPTH TOPSOIL.

| 0005 | OTV | DOTANIOAL NAME | 00141401111414 | 0.75 | NOTES | |
|-------|--------|-------------------------------------|------------------------|-------------|-------|---------|
| CODE | QTY | BOTANICAL NAME | COMMON NAME | SIZE | NOTES | |
| TREES | | | | | | |
| AR | 4 | ACER RUBRUM | RED MAPLE | 2"-2.5" CAL | | |
| AS | 2 | ACER SACCHARUM | SUGAR MAPLE | 3.5" CAL. | | |
| CC | 5 | CERCIS CANADENSIS | EASTERN REDBUD | 2"-2.5" CAL | | |
| QB | 3 | QUERCUS BICOLOR | SWAMP WHITE OAK | 3.5" CAL. | | |
| QR | 6 | QUERCUS RUBRA | RED OAK | 2.5-3" CAL. | B&B | |
| UA | 2 | ULMUS AMERICANA 'PRINCETON' | PRINCETON AMERICAN ELM | 2"-2.5" CAL | | |
| CODE | QTY | BOTANICAL NAME | COMMON NAME | SIZE | | SPACING |
| | • | | • | , | | • |
| | S, PER | ENNIALS, GROUNDCOVER | | | | |
| CA | | CLETHRA ALNIFOLIA | SUMMERSWEET | | | |
| CP | | COMPTONIA PEREGRINA | LOWBUSH BLUEBERRY | | | |
| FG | | FOTHERGILLA GARDENII | WHORLED MILKWEED | | | |
| RA | | RHUS AROMATICA 'GRO-LOW' | DWARF FRAGRANT SUMAC | | | |
| EP | | ATHYRIUM ANGUSTUM (FILIX-FEMINA) | NORTHERN LADY FERN | | | |
| IC | | DRYOPTERIS MARGINALIS | MARGINAL WOODFERN | | | |
| LS | | OSMUNDASTRUM CINNAMOMEA | CINNAMON FERN | | | |
| MR | | OSMUNDA CLAYTONIANA | INTERRUPTED FERN | | | |
| SH | | OSMUNDA REGALIS | ROYAL FERN | | | |
| OS | | ONOCLEA SENSIBILIS | SENSITIVE FERN | | | |
| PA | | POLYSTICHUM ACROSTICHOIDES | CHRISTMAS FERN | | | |
| AC | | ANEMONE CANADENSIS | CANADA ANEMONE | | | |
| AQC | | AQUILEGIA CANADENSIS | RED COLUMBINE | | | |
| CAP | | CAREX PENSYLVANICA | PENNSYLVANIA SEDGE | | | |
| GM | | GERANIUM MACULATUM | WILD GERANIUM | | | |
| HD | | HELIANTHUS DIVARCATUS | WOODLAND SUNFLOWER | | | |
| AT | | ASCLEPIAS TUBEROSA | BUTTERFLY MILKWEED | | | |
| ES | | ERAGROSTIS SPECTABILIS | PURPLE LOVEGRASS | | | |
| MF | | MONARDA FISTULOSA | WILD BERGAMOT | | | |
| PV | | PANICUM VIRGATUM | SWITCHGRASS | | | |
| RH | | RUDBECKIA HIRTA | BLACK-EYED SUSAN | | | |
| SS | | SCHIZACHYRIUM SCOPARIUM | LITTLE BLUESTEM | | | |
| SSP | | SOLIDAGO SPECIOSA | SHOWY GOLDENROD | | | |
| SH | | SPOROBOLUS HETEROLEPIS | PRAIRIE DROPSEED | | | |
| SN | | SYMPHYOTRICUM NOVAE-ANGLIAE | NEW ENGLAND ASTER | | | |
| | | | | | | |

LEGEND

PROPERTY LINELIMIT OF WORK LINE

BORDERING VEGETATED WETLAND

AE ZONE ELEV. 40 FEMA 100 YEAR FLOOD ZONE BORDERING LAND SUBJECT TO FLOODING (LSF)

ZONE X

25 NO DISTURB'

30' MINIMUM SETBACK FOR ASSUMED RETAINING WALLS, OTHER SOLID/IMPERVIOUS CONSTRUCTION

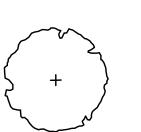
75' BUFFER ZONE

100' BUFFER ZONE 0'-100' OUTER RIPARIAN ZONE

RIVER FRONT AREA

100'-200' OUTER RIPARIAN ZONE
RIVER FRONT AREA

MATCH LINE




MATCH LINE


DECIDUOUS TREE



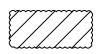LOAM AND SEED



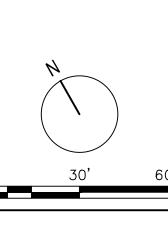SHRUB / GROUNDCOVER / PERENNIAL PLANTING





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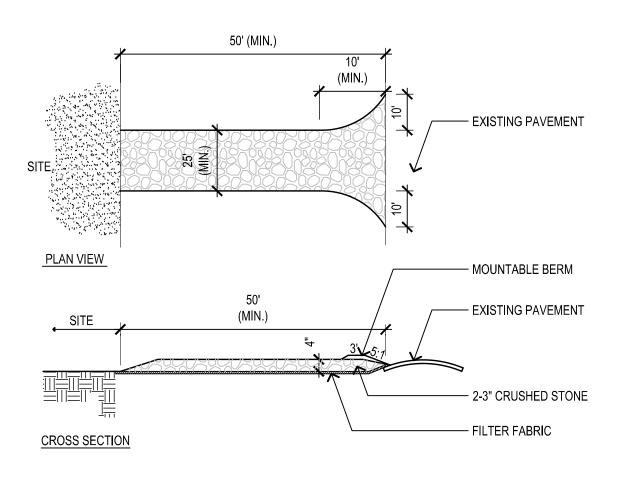
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SYNTHETIC TURF FIELDS NOTICE OF INTENT BOXFORD, MA

Project No.: 210801991 Scale: AS NOTED

PLANTING PLAN

Drawing No. LP-101

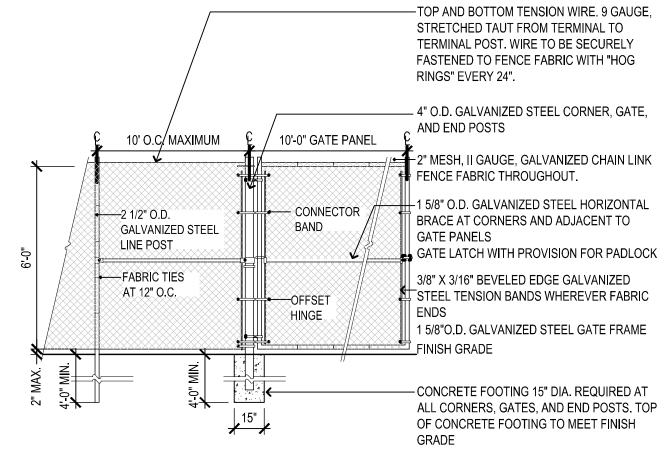


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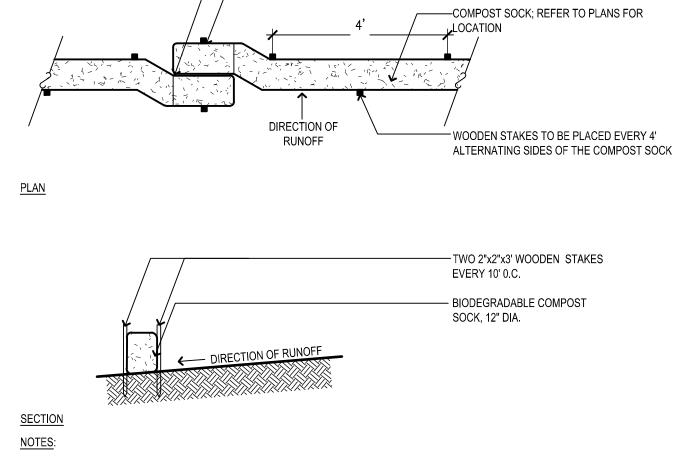
- 1. ENTRANCE WIDTH SHALL BE A TWENTY-FIVE (25) FOOT MINIMUM, BUT NOT LESS THAN THE FULL WIDTH AT POINTS WHERE INGRESS OR EGRESS OCCURS.
- 2. THE ENTRANCE SHALL BE MAINTAINED IN A CONDITION WHICH SHALL PREVENT TRACKING OR FLOWING OF SEDIMENT ONTO PUBLIC RIGHTS-OF-WAY. THIS MAY REQUIRE PERIODIC TOP DRESSING WITH ADDITIONAL STONE AS CONDITIONS DEMAND AND REPAIR OR CLEANOUT OF ANY MEASURES USED TO TRAP SEDIMENT. ALL SEDIMENT SPILLED, DROPPED, WASHED OR TRACKED ONTO PUBLIC RIGHTS-OF-WAY MUST BE REMOVED IMMEDIATELY. BERM SHALL BE PERMITTED. PERIODIC INSPECTION AND MAINTENANCE SHALL BE PROVIDED AS NEEDED.



DETAIL-FILE



ALL MATERIALS SHALL BE GALVANIZED STEEL UNLESS OTHERWISE NOTED.



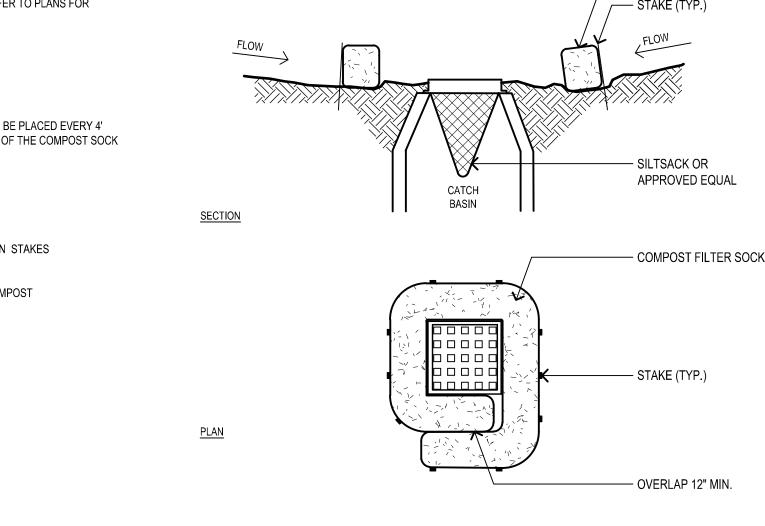
BIODEGRADABLE COMPOST FILTER SOCK

- ALL ENDS ARE TO OVERLAP 12" MIN. TO BUILD

DETAIL-FILE

CONTINUOUS ROWS

 COMPOST SOCK 12" DIA. COMPOST SOCK SHALL BE FULLY BIODEGRADABLE.



CATCH BASIN WITH COMPOST SOCK

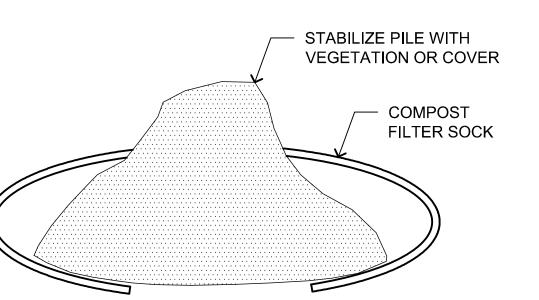
DETAIL-FILE

— COMPOST FILTER SOCK

6' CHAIN LINK CONSTRUCTION FENCE AND GATE

KEY IN TOP OF BLANKET BY CONSTRUCTING A 6" DEEP X 6" WIDE ANCHOR TRENCH WITH APPROXIMATELY 1'-0" OF BLANKET EXTENDING BEYOND THE UP-SLOPE PORTION OF THE TRENCH. ANCHOR THE BLANKET WITH A ROW OF STAPLES/STAKES APPROXIMATELY 1'-0" APART IN THE BOTTOM OF THE TRENCH. BACKFILL AND COMPACT THE TRENCH AFTER STAPLING. APPLY SEED TO COMPACTED SOIL AND FOLD REMAINING 1'-0" PORTION OF BLANKET BACK OVER SEED AND COMPACTED SOIL. SECURE BLANKET OVER COMPACTED SOIL WITH A ROW OF STAPLES/STAKES SPACED APPROXIMATELY 1'-0" APART ACROSS THE WIDTH OF - EROSION CONTROL BLANKET, NORTH AMERICAN GREEN S150 OR APPROVED EQUAL, INSTALLED AND STAPLED PER MANUFACTURER'S RECOMMENDATIONS. - PREPARE SOIL INCLUDING APPLICATION OF LIME, FERTILIZER AND SEED PRIOR TO INSTALLING BLANKET — FINISHED GRADE

EROSION CONTROL BLANKET



SOIL STOCKPILES: FOR ANY STOCKPILES OR LAND CLEARING DEPRIS COMPOSED, IN WHOLE OR IN PART, OF SEDIMENT OR SOIL, THE FOLLOWING MEASURES MUST BE FOLLOWED:

- LOCATE THE PILES OUTSIDE OF ANY NATURAL BUGGERS AND PHYSICALLY SEPARATED FROM THE OTHER STORMWATER CONTROLSIMPLEMENTED, OUTSIDE OF RESOURCE AREAS AND OUTSIDE THE 50' BUFFER ZONE
- PROTECT FROM CONTACT WITH STORMWATER (INCLUDING) RUN-ON) USING A TEMPORARY PERIMETER SEDIMENT BARRIER OF COMPOST FILTER SOCK.
- PROVIDE COVER OR APPROPRIATE TEMPORARY STABILIZATION TO AVOIDDIRECT CONTACT WITH PRECIPITATION OR TO MINIMIZE SEDIMENT DISCHARGE.
- DO NOT HOSE DOWN OR SWEEP SPOIL OR SEDIMENT ACCUMULATED ON PAVEMENT OR OTHER IMPERIOUS SURFACES INTO ANY STORMWATER CONVEYANCE (UNLESS CONNECTED TO A SEDIMENT BASIN, SEDIMENT TRAP, OR SIMILARLY EFFECTIVE CONTROL), STORM DRAIN INLET OR SURFACE WATER
- UNLESS INFEASIBLE, CONTAIN SECURELY TO PROTECT FROM WIND

SOIL STOCKPILE CONTROL

—— 2" X 2" X 36" WOODEN STAKES - INSTALL EROSION CONTROL BLANKET ON ALL SLOPES PLACED 10' O.C. STEEPER THAN 2:1 (H:V) PROTECTED - 6-INCH (MAXIMUM) LAYER OF COMPOST MIX COMPOST FILTER SOCK FLOW → COMPACTED BACKFILL WORK AREA —— 18" DIAMETER COMPOST FILTER SOCK / ALTERNATE STAKING OVERLAPPING SECTIONS FORM CONNECTIONS CONNECTION/ATTACHMENT DETAIL NOTES:

- PREFABRICATED COMPOST SOCK SHALL BE FILTREXX SOXX OR APPROVED EQUAL. MATERIAL FOR SIOCKS SHALL CONSIST OF SANITIZED MATURE COMPOST, FREE OF VIABLE WEED SEEDS AND FOREIGN DEBRIS SUCH AS GLASS AND PLASTIC. COMPOST SHALL BE IN SHREDDED OR GRANULAR FORM AND FREE FROM HARD LUMPS. IN ADDITION, NO FILN-DRIED WOOD OR CONSTRUCTION DEBRIS SHALL BE ALLOWED. CONTRACTOR SHALL REFER TO MASSDOT SPECIFICATIONS M1.06.0 FOR MATERIAL SPECIFICATIONS.
- SOCK SHALL CONSIST OF JUTE MESH OR OTHER APPORVED BIODEGRADABLE MATERIAL. ON SLOPES BETWEEN 2:1 AND 1.5:1 (H:V) THE CONTRACTOR SHALL INSTALL BIONET S150BN BIODEGRADABLE EROSION CONTROL BLANKETS AS MANUFACTURED BY NORTH
- AMERICAN GREEN, OR SIMILAR PRODUCT TO BE APPROVED BY GEOTECHNICAL ENGINEER, OVER THE 6" LAYER OF COMPOST MIX. 5. BLANKETS SHALL BE SECURED PER MANUFACTURER'S INSTRUCTIONS.

COMPOST SLOPE PROTECTION

EXISTING TREE PROTECTION

DETAIL-FILE

- EXISTING TREE; WRAP WITH TWO LAYERS OF BURLAP AND WITH TWO LAYERS OF STANDARD SNOW FENCE, WIRE TO

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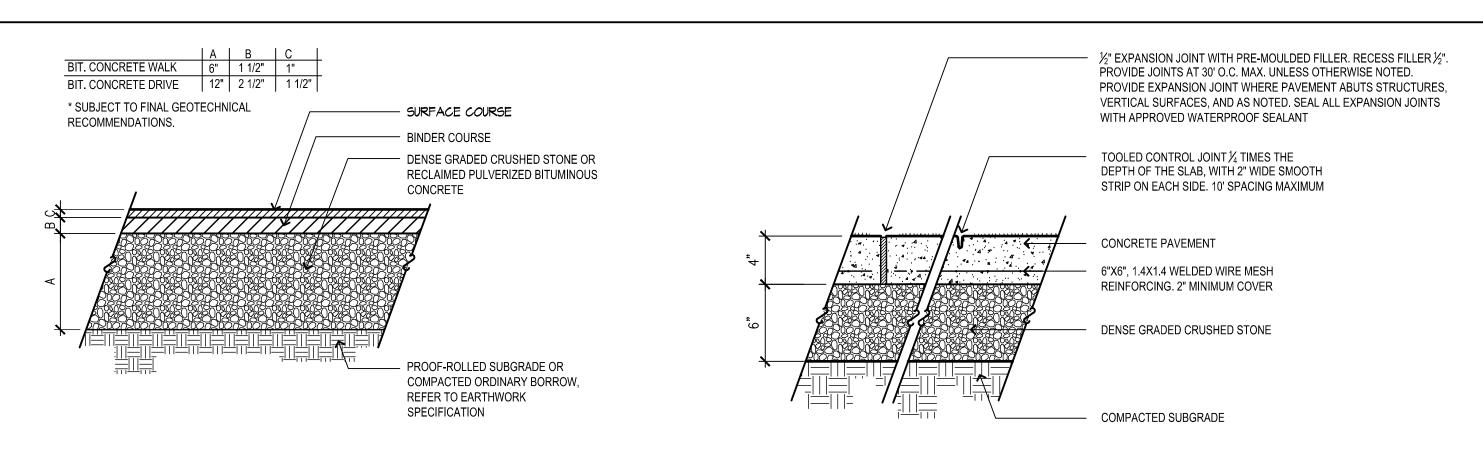
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FASTEN SECURELY. TREE PROTECTION FENCE. USE STANDARD CHAIN LINK FENCE, 6'HT. — METAL POST TO SUPPORT FENCE, (6 REQUIRED), DRIVEN INTO THE GROUND 2'-0" MINIMUM, EQUAL SPACING AROUND TREE.

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- SYNTHETIC TURF CARPET INFILL MATERIAL, FINISH GRADE IS TOP OF INFILL: REFER TO SPECIFICATIONS RESILIENT PAD; REFER TO SPECIFICATIONS FREE DRAINING FINISHING STONE; REFER TO SPECIFICATIONS FREE DRAINING CRUSHED STONE; REFER TO INFILLED SYNTHETIC TURF SPECIFICATIONS GEOTEXTILE; REFER TO SPECIFICATIONS - COMPACTED SUBGRADE SUBGRADE ELEVATION SHALL FOLLOW FINISH GRADE ELEVATIONS — 12" PERFORATED FLAT DRAIN

1 BITUMINOUS CONCRETE PAVING

2 CONCRETE PAVING

3 INFILLED SYNTHETIC TURF SYSTEM

¹/₂" CHAMFER EDGE CORE DRILL CHAIN LINK FENCE POSTS, GROUT POSTS 4" WIDE, 2" DEEP SHELF TO ADHERE TO SECURE IN ANCHOR INFILLED SYNTHETIC TURF SYSTEM CAST IN PLACE CONCRETE TURF FINISH GRADE, EDGE - INFILLED SYNTHETIC TURF SYSTEM ANCHOR, PROVIDE SMOOTH EDGES VARIES, REFER TO LAYOUT AND ARCHITECTURAL QUALITY LIGHT AND MATERIALS PLAN BROOM FINISH TO EXPOSED SURFACES FREE DRAINING CRUSHED STONE -+VARIES 3/4" CRUSHED STONE BEDDING

4'MIN

FINISH GRADE, EDGE VARIES, REFER LAYOUT AND MATERIALS PLAN - CORE DRILL FENCE POSTS, GROUT POSTS TO SECURE IN ANCHOR; WHERE REQUIRED $\frac{1}{2}$ " CHAMFER EDGE 2" THICK OUTDOOR ATHLETIC PADDING FULLY WRAP ENDS AND ANY EXPOSE SIDES. REFER TO SPECIFICATIONS FOR COLOR. - 4" WIDE, 2" DEEP SHELF TO ADHERE INFILLED SYNTHETIC TURF SYSTEM CAST IN PLACE CONCRETE TURF ANCHOR, PROVIDE SMOOTH EDGES AND 1'-2" ARCHITECTURAL QUALITY LIGHT BROOM FINISH TO EXPOSED SURFACES INFILLED SYNTHETIC TURF SYSTEM 6X8 #4 X 30'-0" @18" W/LAP25" 8 #4 20'-0" @18"H 3/4" CRUSHED STONE BEDDING PROOF-ROLLED SUBGRADE OR COMPACTED ORDINARY BORROW, REFER TO EARTHWORK SPECIFICATION.

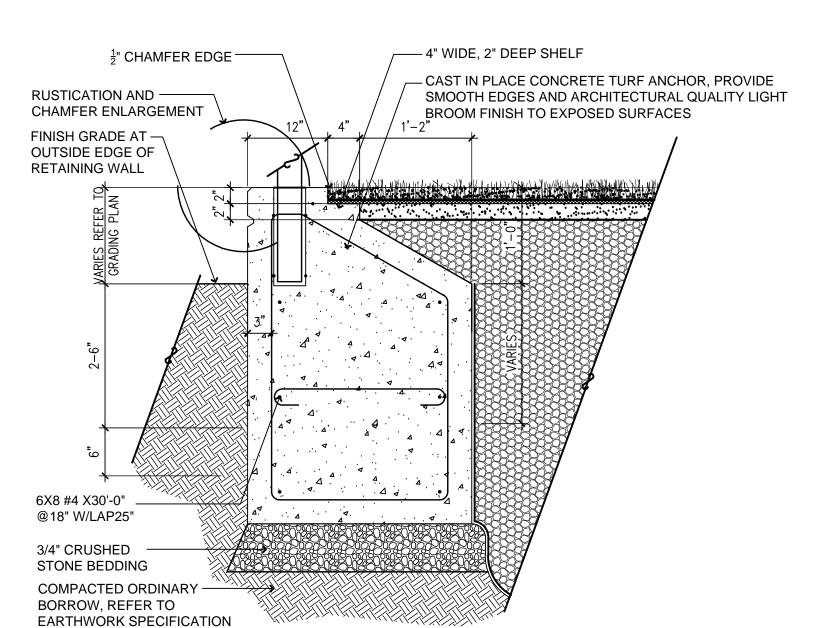
4) CAST-IN-PLACE CONCRETE TURF ANCHOR - TYPE A

PROOF-ROLLED SUBGRADE OR

TO EARTHWORK SPECIFICATION.

COMPACTED ORDINARY BORROW, REFER


5 CAST-IN-PLACE CONCRETE TURF ANCHOR - TYPE B
NOT TO SCALE



- FENCE POST RUSTICATION -- 8"X8" BASE PLATE **ENLARGEMENT** - 1" CHAMFERED TOP, BOTH SIDES - MINIMUM 3" COVER AT ALL EDGES - INFILLED SYNTHETIC TURF SYSTEM - TURF ANCHOR ENLARGEMENT - REINFORCING, SEE CHART COMPACTED GRAVEL SECTION 1/4"=1'-0" CONCRETE DIMENSIONS REINFORCING

FREE DRAINING TRENCH STONE

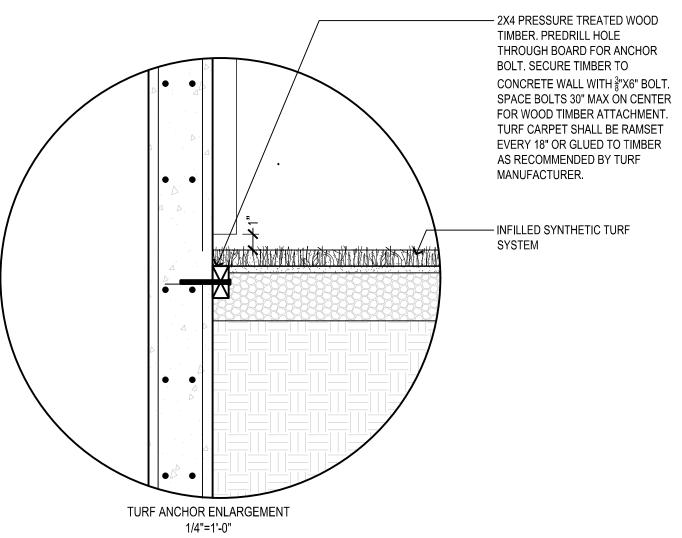— 18" DIA. HDPE PIPE



FENCING OR ATHLETIC -BALL NETTING POLE, RUSTICATION AND EXPANSION JOINTS **TYPICAL** CENTERED BETWEEN FENCE POSTS AND CHAMFER ON ALL -ATHLETIC BALL NETTING POLES TOP EDGES HORIZONTAL WALL RUSTICATION, TYP. FINISH GRADE 3/4" VERTICAL WALL RUSTICATION CENTERED BETWEEN POSTS, TYPICAL EXPANSION JOINT, CENTERED BETWEEN POSTS, TYPICAL **ELEVATION ENLARGEMENT**

RUSTICATION ENLARGEMENT

1-1/2"-1'-0"

CAST-IN-PLACE CONCRETE TURF ANCHOR - TYPE C

NOT TO SCALE

CAST-IN-PLACE CONCRETE TURF ANCHOR - TYPE D

8 RUSTICATION ENLARGEMENT DETAIL

NOT TO SCALE

RUSTICATION -



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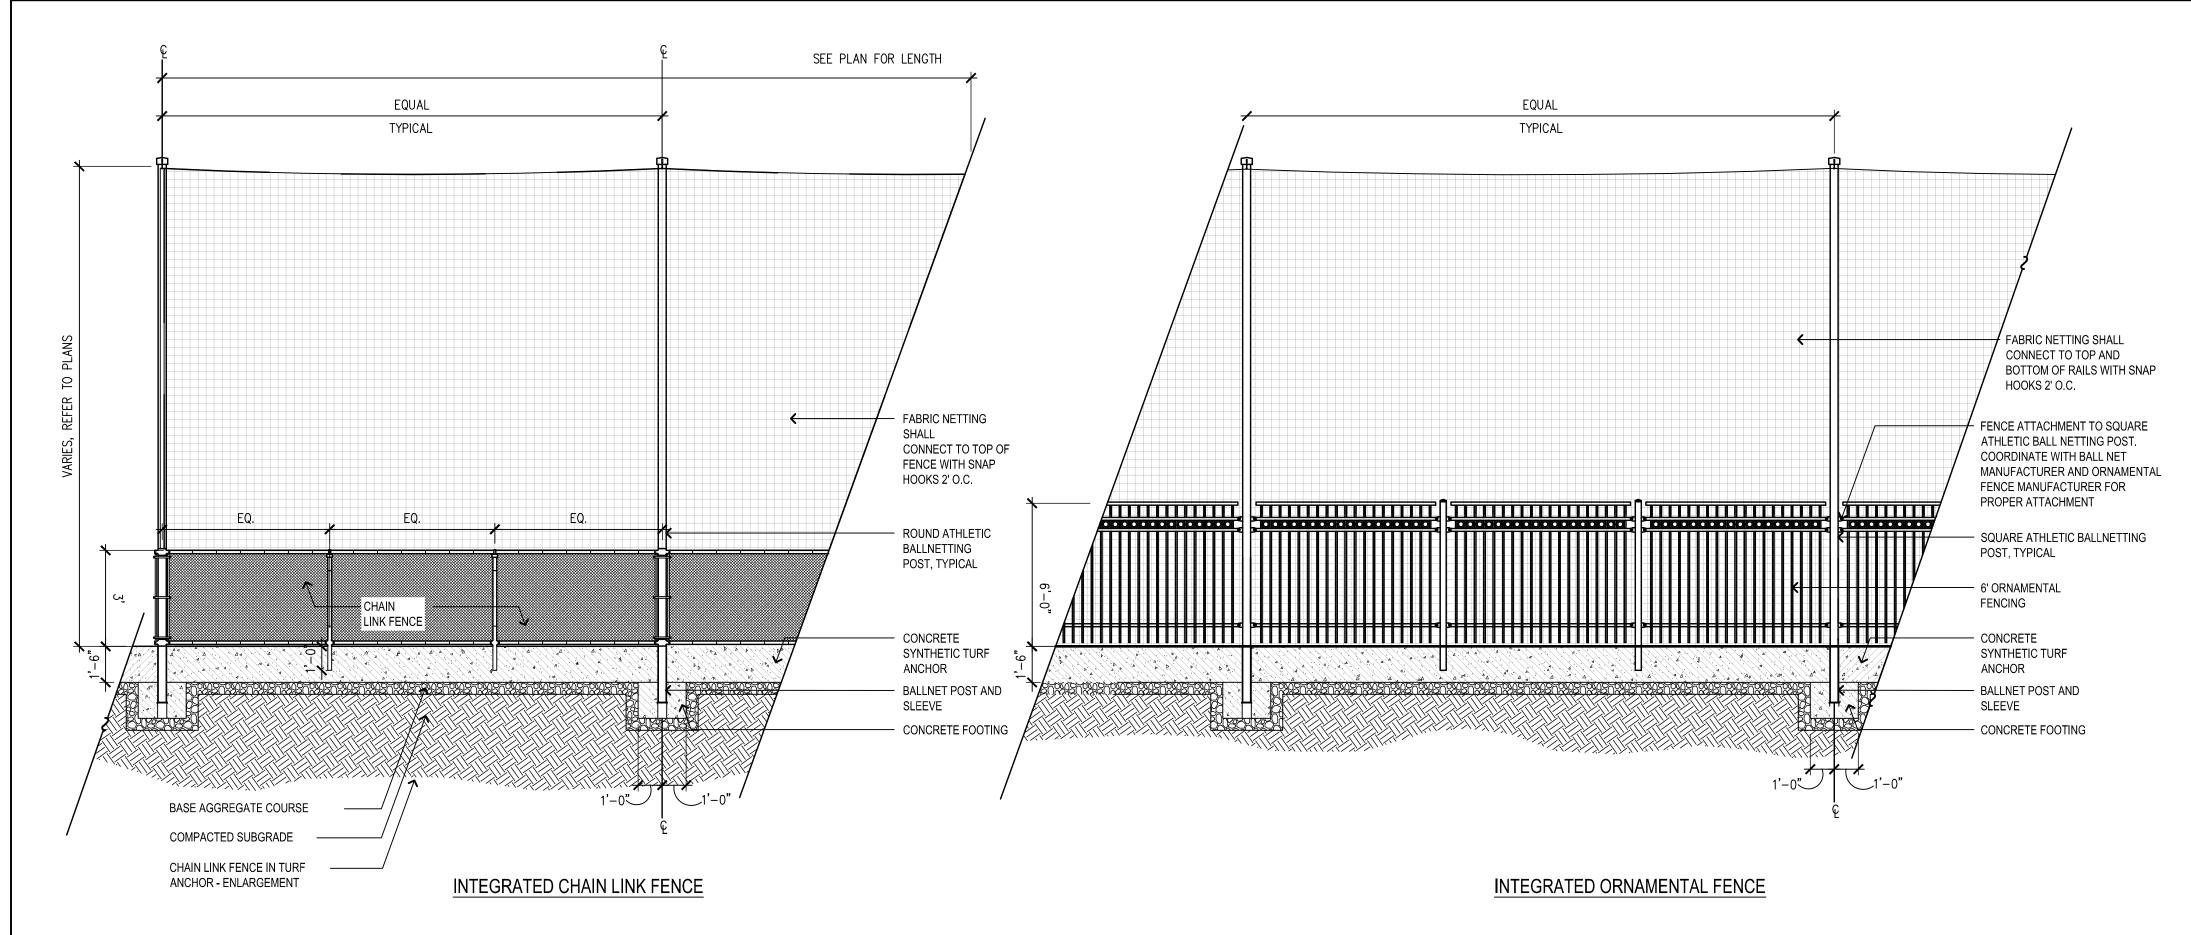
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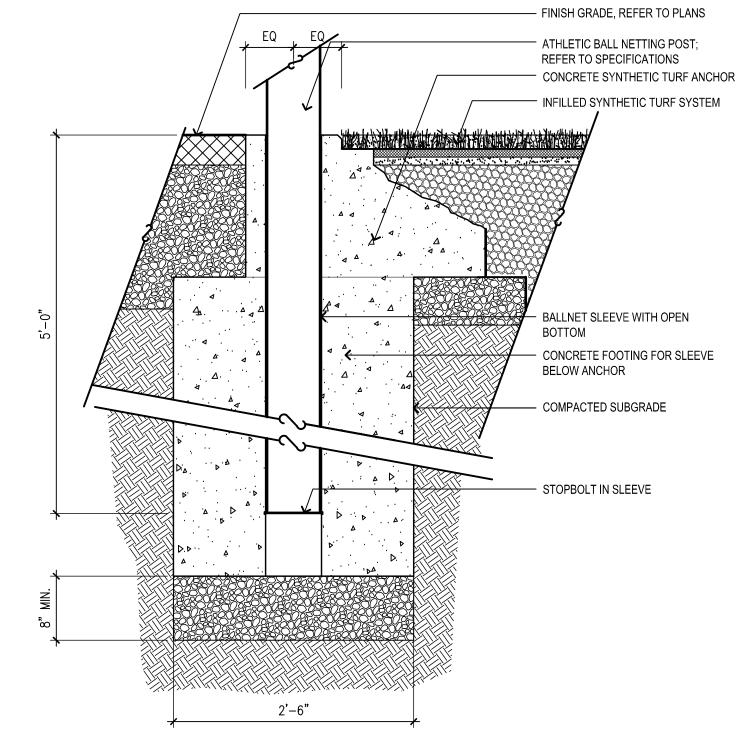
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SITE DETAILS I

Drawing No.

ORIGINAL SHEET - ARCH D





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SITE DETAILS II

Drawing No. LS-502

ATHLETIC BALL NETTING AND INTEGRATED FENCE IN TURF ANCHOR

9 GAUGE FABRIC — TIES 12" O.C. REFER 8' MAX. — POST CAP LOOP CAP ----—— TOP RAIL SLEEVE — TOP RAIL — TENSION BARS WHEREVER FABRIC ENDS — LINE POST — CONNECTOR BAND — BLACK DIAMOND FABRIC, KNUCKLED SELVAGE, TOP AND BOTTOM TRUSS ROD WITH — HORIZONTAL BRACE TURNBUCKLE _ TERMINAL POSTS CORNER, GATE, AND END POSTS ----- FINISH GRADE — CONCRETE FOOTING - REQUIRED AT ALL CORNER, GATE, AND END POSTS 18" BOTTOM RAIL ----

1. REFER TO SPECIFICATIONS FOR FRAMEWORK AND FABRIC SIZING AND MATERIALS.

2. POST SPACING SHALL BE EQUIDISTANT

CHAIN LINK FENCE IN TURF ANCHOR

CHAIN LINK SINGLE GATE

_ 9 GAUGE FABRIC TIES, 12" O.C., 1. REFER TO SPECIFICATIONS FOR REFER TO SPECIFICATIONS FRAMEWORK, FITTINGS, AND FABRIC GATE PANEL - SEE PLAN FOR WIDTH SIZING AND MATERIALS. 2. REFER TO CHAIN LINK FENCE _HORIZONTAL/ VERTICAL INTERIOR DETAIL AND SPECIFICATIONS FOR MEMBER, ONLY REQ. ON GATE 8' FOOTING SIZING AND HIGH OR TALLER OR 15' WIDE OR REQUIREMENTS. LONGER 3. POST SPACING SHALL BE **EQUIDISTANT** —— DIAMOND FABRIC, KNUCKLED SELVAGE, TOP AND BOTTOM CONNECTOR BAND GATE LATCH WITH PROVISION FOR PADLOCK _____ TENSION BAR WHEREVER FABRIC CONCRETE FOOTING DEPTH AND WIDTH
FENCE HEIGHT 3'
TERMINAL 48"x15"
LINE 48"x12" — CAST-IN-PLACE CONCRETE TURF ANCHOR

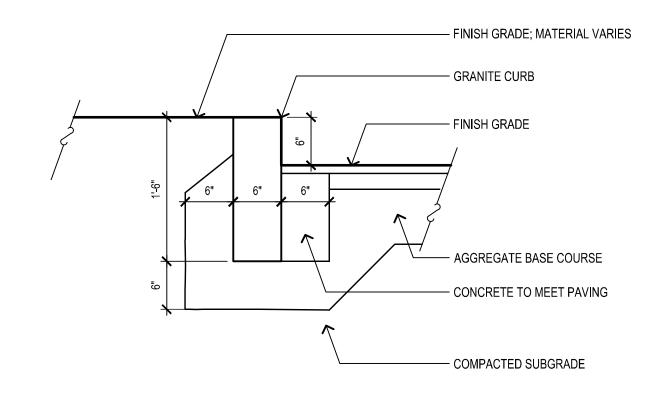
DOUBLE GATE PANEL - 8' TOTAL WIDTH — FULLY WELD TOP RAIL TO GATE POSTS TOP RAIL SLEEVE - CHAIN LINK MESH, SPECIFICATIONS CHAIN LINK FENCE - BOULEVARD CLIPS PROVISION FOR — STRETCHER BAR WHEREVER FABRIC ENDS MATERIAL VARIES, REFER TO PLANS —GATE LEAVES SHALL OPEN A FULL 180° WITH THE ABILITY FOR THE CAM BOLT TO SECURE GATE IN OPEN AND CLOSED POSITIONS

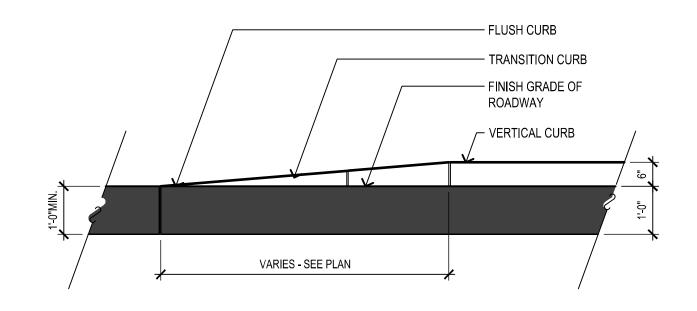
ATHLETIC BALL NETTING POST

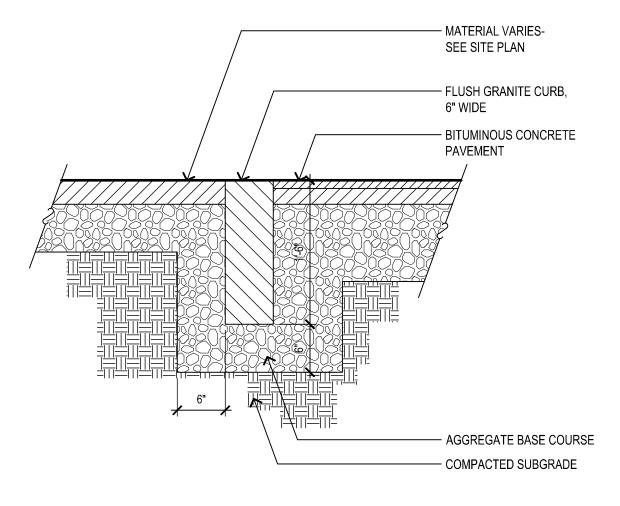
CHAIN LINK DOUBLE GATE

ORIGINAL SHEET - ARCH D

-LOCKABLE CANE









VERTICAL GRANITE CURB

TRANSITION FROM VERTICAL CURB TO FLUSH CURB

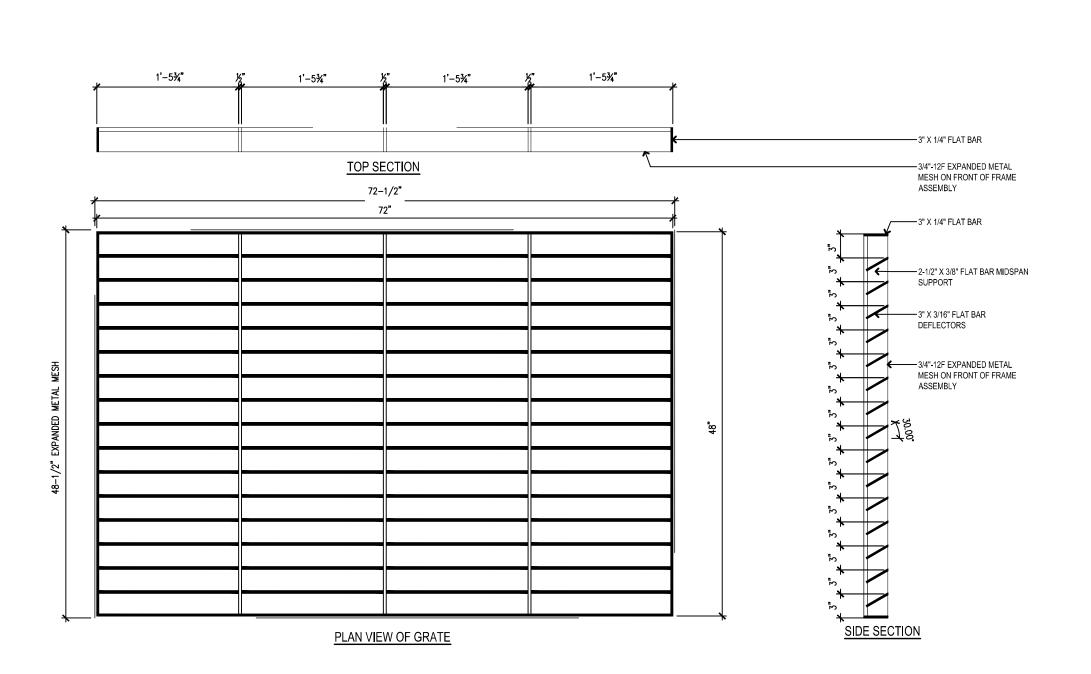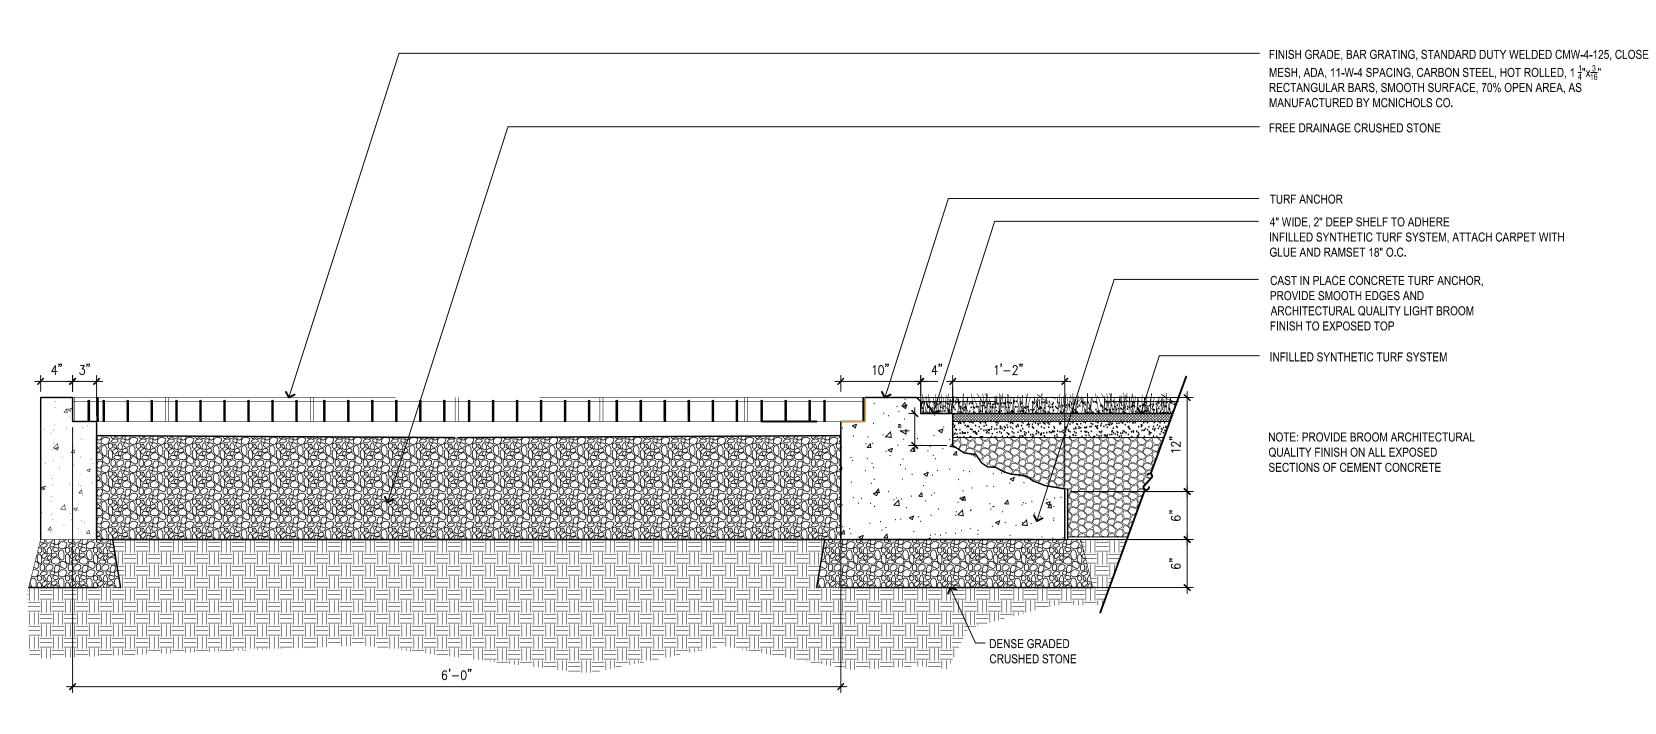FLUSH GRANITE CURB





SECTION

GRATE BOARDWALK



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4" WIDE, 2" DEEP SHELF TO ADHERE
INFILLED SYNTHETIC TURF SYSTEM, ATTACH CARPET WITH
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FINISH TO EXPOSED TOP INFILLED SYNTHETIC TURF SYSTEM

NOTE: PROVIDE BROOM ARCHITECTURAL QUALITY FINISH ON ALL EXPOSED SECTIONS OF CEMENT CONCRETE


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SITE DETAILS III

Drawing No. LS-503



90'-4" GOAL CIRCLE 8 METER ARC NOTE: ALL ENDLINES AND SIDELINES ARE CONSIDERED OUT OF BOUNDS 14'-914'-91 SUBSTITUTION AREA

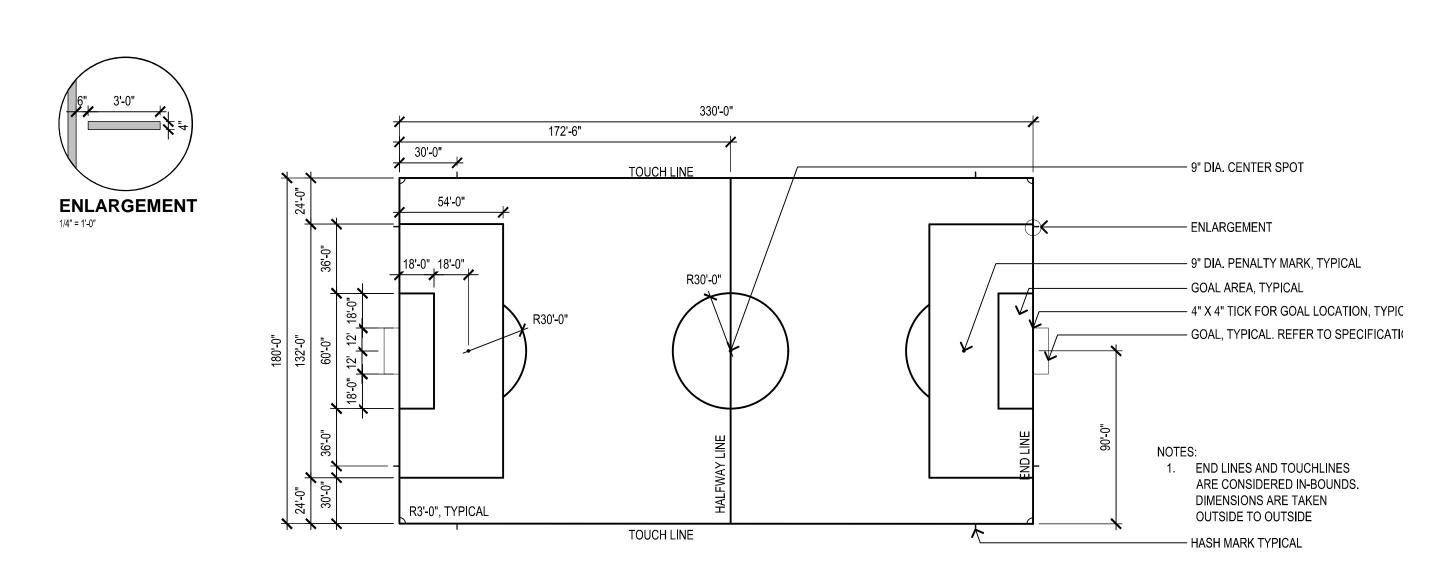SIDE LINE

12" LONG LONG HIT

1' LONG HASH MARKS,

2" LONG PENALTY

24" HASHMARK TO _____

12" LONG PENALTY CORNER

6' LONG ALLEY MARKER, -

300'

STROKE LINE

LINES, TYPICAL

TYPICAL 15' LONG 16-YARD HIT

LINE, TYPICAL

EQUAL

1. ALL MEASUREMENTS TAKEN FROM HALFWAY LINE TO INSIDE EDGE LINE.

2. GIRLS' LACROSSE SIDE AND ENDLINES ARE CONSIDERED OUT OF BOUNDS.

3. SHOP DRAWINGS OF FIELD MARKINGS TO BE SUBMITTED TO LANDSCAPE ARCHITECT FOR APPROVAL.

4. ON MARKINGS: LETTER MEANS WHAT SPORT NUMBER MEANS SIZE OF TICK

FIELD HOCKEY SIDE AND ENDLINES ARE

2. SHOP DRAWINGS OF FIELD MARKINGS TO

BE SUBMITTED TO LANDSCAPE

ARCHITECT FOR APPROVAL.

3. ALL FIELD HOCKEY LINES TO BE

CONSIDERED IN BOUNDS.

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SITE DETAILS IV

DETAIL-FILE

NFHS GIRLS LACROSSE FIELD LAYOUT

— TUFTED SIDELINE AND ENDLINE TAKEN TO INSIDE EDGE OF LINE 165'-0" (BOYS LAX ENDLINE) 60'-0**"** — ENLARGEMENT 60'-0" **ENLARGEMENT** (25 YARD LINE) 1/8" = 1'-0" WING LINE WING LINE - 4" WIDE CENTER LINE - 4"x4" CENTER SQUARE 1. ALL MEASUREMENTS TAKEN FROM BOYS LAX GOAL LINE BOYS' LACROSSE SIDE AND ENDLINES ARE CONSIDERED OUT OF WING LINE WING LINE 3. B = BOYS' LACROSSE 4. SHOP DRAWINGS OF FIELD MARKINGS TO BE SUBMITTED TO LANDSCAPE ARCHITECT FOR

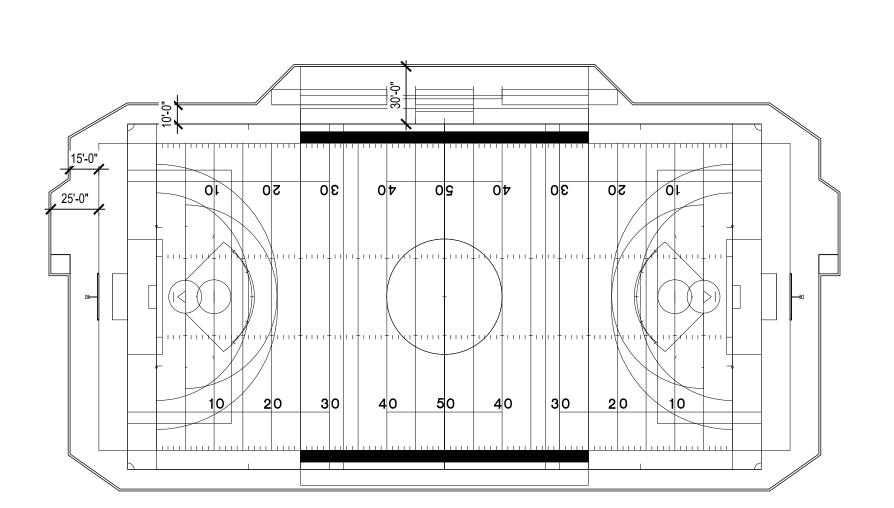
> 5. ON MARKINGS: LETTER MEANS WHAT SPORT NUMBER MEANS SIZE OF TICK

DETAIL-FILE

NFHS BOYS LACROSSE FIELD LAYOUT

1"=50"

NOTES:
1. ALL MEASUREMENTS TAKEN FROM INSIDE 2. FOOTBALL SIDE AND ENDLINES ARE CONSIDERED OUT OF BOUNDS. — INLAID NUMERALS 3. SHOP DRAWINGS OF FIELD MARKINGS TO BE SUBMITTED TO LANDSCAPE ARCHITECT FOR APPROVAL. — 4" TUFTED 5 YARD LINE TEAM AREA 4. ON MARKINGS: LETTER MEANS WHAT SPORT NUMBER **ENLARGEMENT** MEANS SIZE OF TICK 1/16" = 1'-0" - END ZONE LINES AND SIDELINES SHALL BE 8" WIDE - REMOVABLE GOAL POST, TYPICAL. FACE OF CROSSBAR TO ALIGN WITH FIELD SIDE EDGE OF BACK END ZONE LINE - ENLARGEMENT TEAM AREA 300'-0" 360'-0"



FIELD 2 LINE LAYOUT


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Drawing No. LS-504

NFHS FOOTBALL FIELD LAYOUT (FIELD 2)

NFHS SOCCER FIELD LAYOUT (FIELD 2)

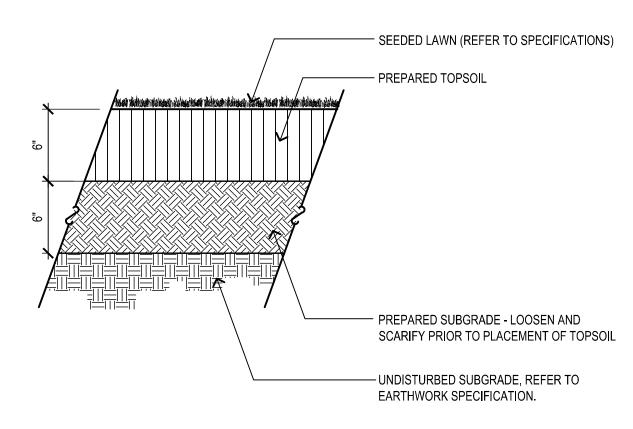NFHS BOYS LACROSSE FIELD LAYOUT



REFER TO PLAN FOR SPACING REQUIREMENTS ---- 3" MULCH COVER TO HOMOGENOUS MIXTURE RIPPED OR SCARIFIED SUBGRADE, SLOPE WITH FINISHED GRADE - EXISTING SUBGRADE

- 3" BARK MULCH IN SAUCER, NOT TO BE PILED AGAINST ROOT FLARE OR TRUNK - PLANT SAUCER, 4" CONTINUOUS, NO SAUCER WHERE SHRUBS OCCUR IN - FINISH GRADE - CUT AND REMOVE ALL BURLAP FROM **ROOT BALL** - PLANTING SOIL MIX: BACKFILL IN LOOSE LIFTS OF 6"-8" DEPTH. SETTLE WITH THOROUGH WATERING — PLACE ROOT BALL ON UNDISTURBED SOIL. IF SOIL HAS BEEN DISTURBED, COMPACT TO MINIMIZE SETTLING.

— WARNING FLAG 18" ABOVE FINISH GRADE FINISH GRADE -- METAL GROUND ANCHORS; SET ANGLE OF GUYS TO ENTER GROUND AT LIMIT OF BRANCH SPREAD - PLANTING SOIL MIX: BACKFILL IN LOOSE LIFTS OF 6"-8" DEPTH. SETTLE WITH THOROUGH WATERING - CUT AND REMOVE BURLAP FROM TOP 1/3 OF ROOTBALL CUT AND REMOVE WIRE BASKETS ENTIRELY — PLACE ROOT BALL ON UNDISTURBED SOIL; IF SOIL HAS BEEN DISTURBED, PROVIDE COMPACTION TO MINIMIZE SETTLING

CABLE CLAMPS

WIRE AROUND TREE IN ENCASED REINFORCED HOSE, SECURE WIRE ENDS WITH MALLEABLE

— PROVIDE GALVANIZED TURNBUCKLES; ONE PER

- PLANT SAUCER, 4" CONTINUOUS , NO SAUCER

- PLACE ROOTBALL SO THAT ROOT FLARE IS

VISIBLE 1-2" ABOVE FINISH GRADE

WHERE TREES OCCUR IN BEDS

1. TREE SHALL BEAR SAME RELATIONSHIP TO FINISHED GRADE AS IT BORE TO NURSERY OR FIELD GRADE. 2. INSTALL THREE GUYS PER TREE; EQUALLY SPACED AROUND BALL. ATTACH GUYS AT 2/3 HEIGHT OF TREE;

USE DOUBLE STRAND GALVANIZED STEEL WIRE. 3. ROOT FLARE SHALL BE VISIBLE 1-2" ABOVE FINISH GRADE.

EVERGREEN TREE PLANTING

MIN.

3 X WIDTH OF

ROOTBALL

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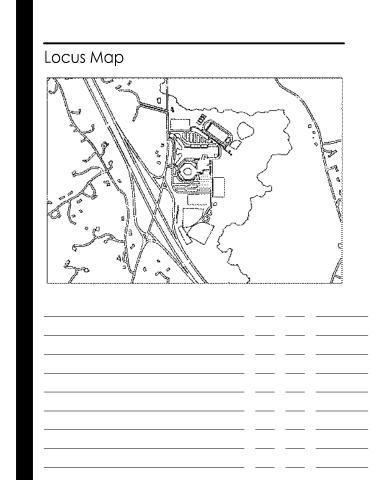
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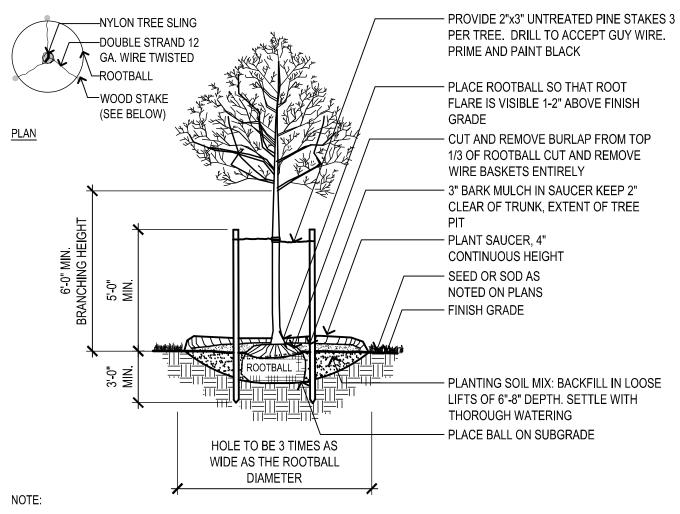
PLANTING DETAILS

Drawing No.

LOAM AND SEED OR SOD PLANTING

DETAIL-FILE

SHRUB PLANTING



- 1. TREE SHALL BEAR SAME RELATIONSHIP TO FINISHED GRADE AS IT BORE TO NURSERY OR FIELD GRADE
- 2. CONTRACTOR MAY USE PLASTIC TREE GUYING CHAIN IF
- APPROVED BY LANDSCAPE ARCHITECT

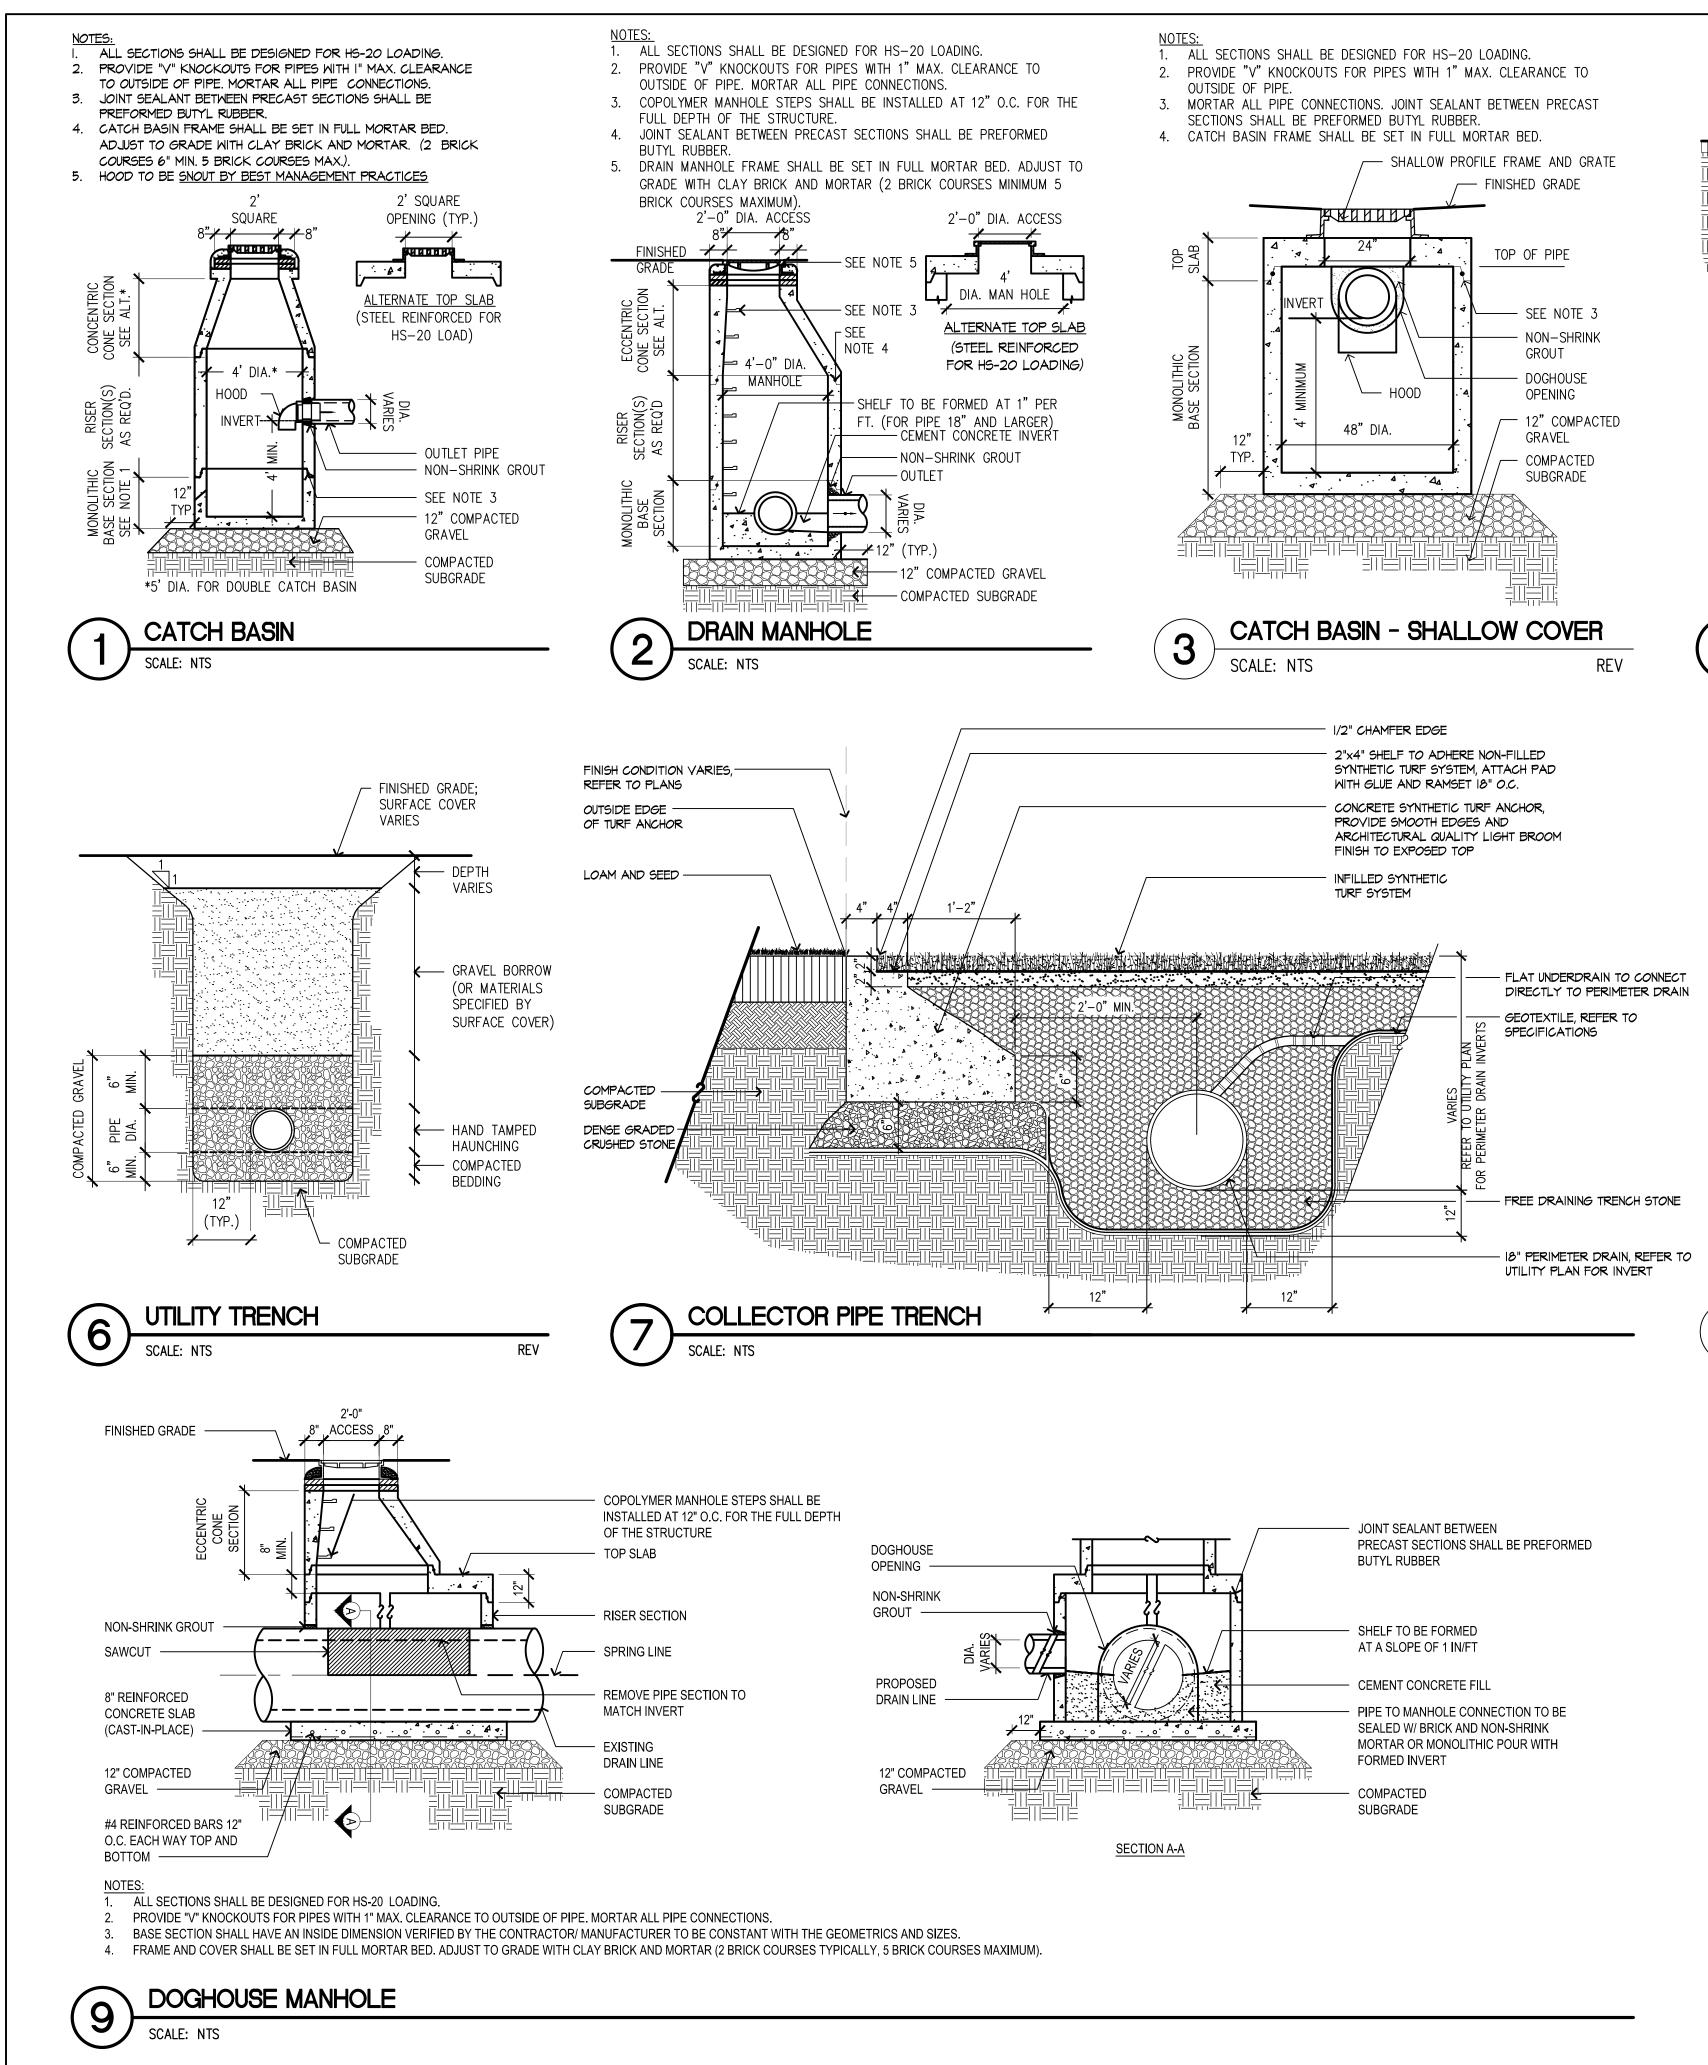
DECIDUOUS TREE PLANTING WITH STAKING

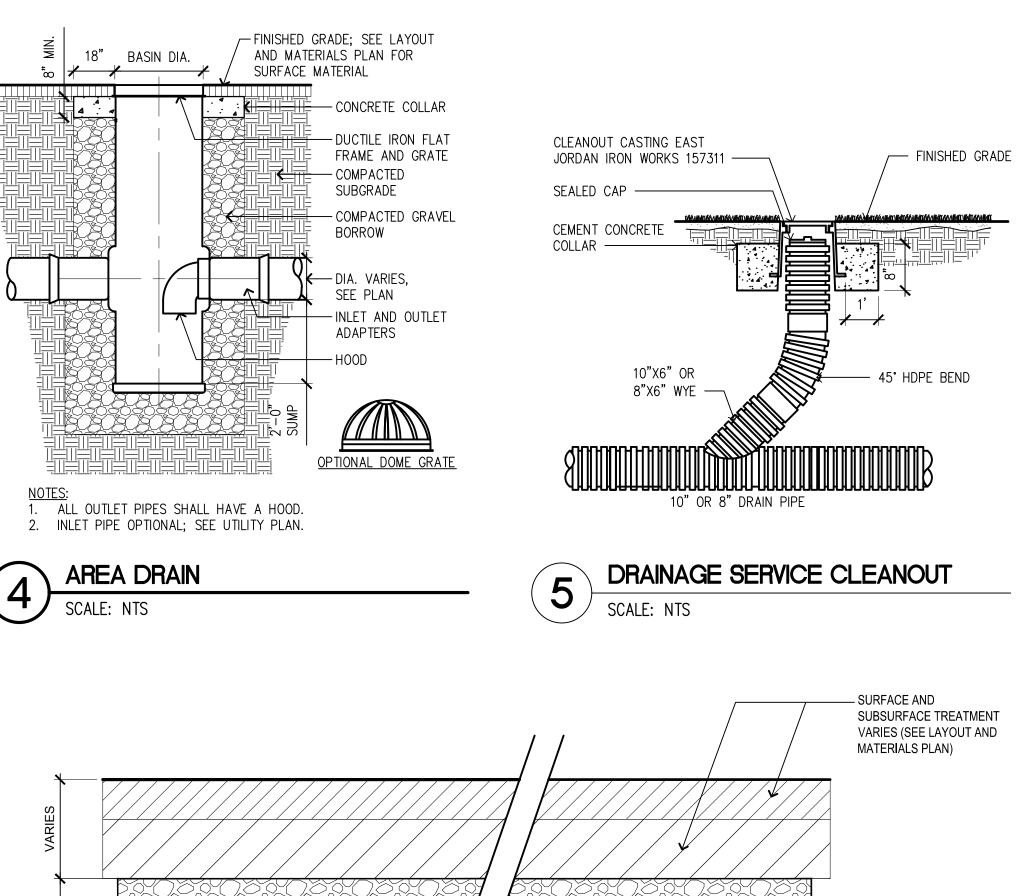
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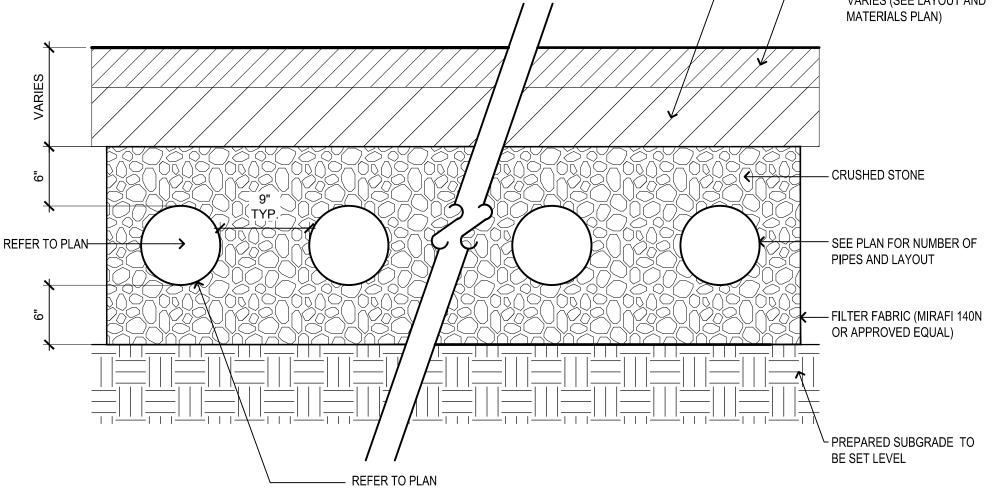
— PLANTING SOIL MIX: 6" MIN TOPSOIL WITH SOIL AMENDMENTS AND EXISTING SOIL, PREPARED NOTES: 1. SHRUB SHALL BEAR SAME RELATIONSHIP TO FINISHED GRADE AS IT BORE TO NURSERY OR FIELD GRADE. 2. WHERE SHRUBS OCCUR IN GROUPINGS IN PLANT BEDS, PROVIDE 2 - FOOT DEEP CONTINUOUS LOAM BED.

GROUND COVER PLANTING


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UNDERGROUND INFILTRATION PIPE SYSTEM


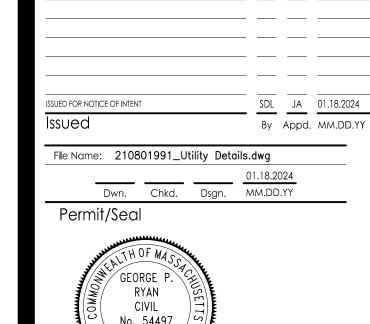
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