

project title:

FAR CORNER GOLF COURSE
CART PATH BRIDGE
REPLACEMENT

prepared for:

ROBERT FLYNN
FAR CORNER GOLF COURSE
5 BARKER ROAD
BOXFORD, MA 01921

parcel identification:

map: 02

block: N.A.

parcel: 01

lot: 08

revisions

no.	date	description
0	10/18/20	ISSUED FOR REVIEW

plan submission


NOTICE OF INTENT
BRIDGE REPLACEMENT

date: 10.18.2020

scale: AS NOTED

job no: 2020-43

DEP no: T.B.D.

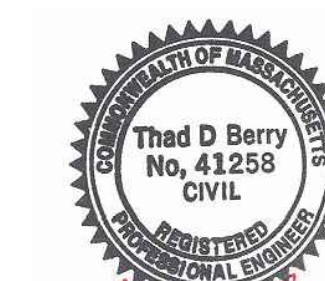

Thad D. Berry

drawing name


SITE PLAN
(AERIAL IMAGE)

drawing number

C1



SITE PLAN
SCALE: 1"=40'
SOURCE: MASSGIS

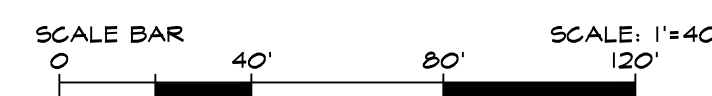

PROJECT GENERAL NOTES

1. EXISTING CONCRETE CART PATH BRIDGE ABUTMENTS ARE TO REMAIN. EXISTING ABUTMENTS MAY BE LOWERED BY SAW CUTTING THE CONCRETE.
2. NEW CART PATH BRIDGE WILL BE PLACED ON HELICAL PILES.
3. NEW CART PATH BRIDGE WILL BE DRILLED IN PLACE THAT WILL CREATE NO SOIL WASTE.
4. HELICAL PILES WILL BE 7" (±) X 4" DIAMETER.
5. ALL DISTURBED AREAS WILL BE LOAMED AND SEEDED.



WETLAND FLAGGING

WETLAND FLAGGING
BY RIMMER ENVIRONMENTAL CONSULTING INC.

INDEX OF SHEETS

- C1 SHEET 1 OF 2 SITE PLAN (AERIAL IMAGE)
C2 SHEET 2 OF 2 EROSION CONTROL DETAILS

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EXISTING CART PATH BRIDGE

NOT TO SCALE
SOURCE: GOOGLE - STREET VIEW



EXISTING CART PATH BRIDGE - PHOTOGRAPH #1


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EXISTING CART PATH BRIDGE - PHOTOGRAPH #1

NOT TO SCALE

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Thad D. Berry

EROSION CONTROL NOTES

EROSION CONTROL PRINCIPLES

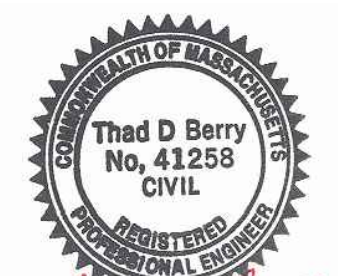A. THE FOLLOWING EROSION CONTROL PRINCIPLES SHALL APPLY TO THE LAND GRADING AND CONSTRUCTION PHASES:

- 1) STRIPPING OF VEGETATION, GRADING, OR OTHER SOIL DISTURBANCE SHALL BE DONE IN A MANNER WHICH WILL MINIMIZE SOIL EROSION.
- 2) WHENEVER FEASIBLE, NATURAL VEGETATION SHALL BE RETAINED AND PROTECTED.
- 3) EXTENT OF AREA WHICH IS EXPOSED AND FREE OF VEGETATION AND DURATION OF ITS EXPOSURE SHALL BE KEPT WITHIN PRACTICAL LIMITS.
- 4) TEMPORARY SEEDING, MULCHING, OR OTHER SUITABLE STABILIZATION MEASURES SHALL BE USED TO PROTECT EXPOSED CRITICAL AREAS DURING PROLONGED CONSTRUCTION OR OTHER LAND DISTURBANCE.
- 5) DRAINAGE PROVISIONS SHALL ACCOMMODATE INCREASED RUNOFF RESULTING FROM MODIFICATIONS OF SOIL AND SURFACE CONDITIONS DURING AND AFTER DEVELOPMENT OR DISTURBANCE. SUCH PROVISIONS SHALL BE IN ADDITION TO EXISTING REQUIREMENTS.
- 6) SEDIMENT SHALL BE RETAINED ON-SITE.
- 7) EROSION CONTROL DEVICES SHALL BE INSTALLED AS EARLY AS POSSIBLE IN THE CONSTRUCTION SEQUENCE PRIOR TO START OF CLEARING AND GRUBBING OPERATIONS AND EXCAVATION WORK.

B. CUT AND FILL SLOPES AND STOCKPILED MATERIALS SHALL BE PROTECTED TO PREVENT EROSION. SLOPES SHALL BE PROTECTED WITH PERMANENT EROSION PROTECTION WHEN EROSION EXPOSURE PERIOD IS GREATER THAN OR EQUAL TO SIX MONTHS, AND TEMPORARY EROSION PROTECTION WHEN EROSION EXPOSURE PERIOD IS EXPECTED TO BE LESS THAN SIX MONTHS (SEE NOTE 10).

- 1) PERMANENT EROSION PROTECTION SHALL BE ACCOMPLISHED BY SEEDING WITH GRASS AND COVERING WITH AN EROSION PROTECTION MATERIAL, AS APPROPRIATE FOR PREVAILING CONDITIONS.
- 2) EXCEPT WHERE SPECIFIED SLOPE IS INDICATED ON DRAWINGS, FILL SLOPES SHALL BE LIMITED TO A GRADE OF 3:1 (HORIZONTAL:VERTICAL) AND CUT SLOPES SHALL BE LIMITED TO A GRADE OF 3:1.

SILTATION SOCK

INSTALL SILTATION SOCK IN ACCORDANCE WITH THE PLAN DETAIL.

MAINTENANCE AND REMOVAL OF CONTROL DEVICES

A. WETLAND AREAS, WATER COURSES, AND DRAINAGE SWALES ADJACENT TO CONSTRUCTION ACTIVITIES SHALL BE MONITORED TWICE EACH MONTH FOR EVIDENCE OF SILT INTRUSION AND OTHER ADVERSE ENVIRONMENTAL IMPACTS, WHICH SHALL BE CORRECTED IMMEDIATELY UPON DISCOVERY.

B. CULVERTS AND DRAINAGE DITCHES SHALL BE KEPT CLEAN AND CLEAR OF OBSTRUCTIONS DURING CONSTRUCTION PERIOD.

C. EROSION CONTROL DEVICES:

- 1) SEDIMENT BEHIND THE EROSION CONTROL DEVICE SHALL BE CHECKED TWICE EACH MONTH AND AFTER EACH HEAVY RAIN. SILT SHALL BE REMOVED IF GREATER THAN 6-INCHES DEEP.
- 2) CONDITION OF EROSION CONTROL DEVICE SHALL BE CHECKED TWICE EACH MONTH OR MORE FREQUENTLY AS REQUIRED. DAMAGED AND/OR DETERIORATED ITEMS SHALL BE REPLACED. EROSION CONTROL DEVICES SHALL BE MAINTAINED IN-PLACE AND IN EFFECTIVE CONDITION.
- 3) HAY BALES SHALL BE INSPECTED FREQUENTLY AND MAINTAINED OR REPLACED AS REQUIRED TO MAINTAIN BOTH EFFECTIVENESS AND INSTALLED CONDITION. UNDERSIDE OF BALES SHALL BE KEPT IN CLOSE CONTACT WITH THE EARTH BELOW AT ALL TIMES, AS REQUIRED TO PREVENT WATER FROM WASHING BENEATH BALES.
- 4) SEDIMENT SHALL BE REMOVED FROM THE RETENTION PONDS AT THE COMPLETION OF THE PROJECT AND PERIODICALLY DURING CONSTRUCTION. SEDIMENT DEPOSITS SHALL BE REMOVED WHEN SEDIMENT HAS ACCUMULATED TO A DEPTH OF 6 INCHES, OR AS DIRECTED.
- 5) SEDIMENT DEPOSITS SHALL BE DISPOSED OF OFF-SITE, IN A LOCATION AND MANNER WHICH WILL NOT CAUSE SEDIMENT NUISANCE ELSEWHERE.

D. REMOVAL OF EROSION CONTROL DEVICES:

- 1) THE CONSERVATION COMMISSION AGENT MUST INSPECT THE SITE AND APPROVE REMOVAL OF ANY EROSION CONTROL DEVICE.
- 2) EROSION CONTROL DEVICES SHALL BE MAINTAINED UNTIL ALL DISTURBED EARTH HAS BEEN PAVED OR VEGETATED, AT WHICH TIME THEY SHALL BE REMOVED. AFTER REMOVAL, AREAS DISTURBED BY THESE DEVICES SHALL BE RE-GRADED AND SEEDED.
- 3) EROSION CONTROL NETTING SHALL BE KEPT SECURELY ANCHORED UNTIL START OF PERMANENT TURF CONSTRUCTION.
- 4) EROSION PROTECTION MATERIAL SHALL BE KEPT SECURELY ANCHORED UNTIL ACCEPTANCE OF COMPLETED SLOPE OR ENTIRE PROJECT, WHICHEVER IS LATER.

LOAM AND SEED NOTES

1. IF REQUIRED THE CONTRACTOR SHALL FURNISH ALL TOPSOIL OR ADDITIONAL TOPSOIL NEEDED TO COMPLETE THE JOB. IF THE EXISTING TOPSOIL IS SUFFICIENT TO COMPLETE THE JOB, ANY EXCESS TOPSOIL WILL REMAIN ON SITE. AN AREA WILL BE PROVIDED ON SITE FOR FINAL STORAGE.
2. THE TOPSOIL SHALL BE UNIFORMLY DISTRIBUTED ON THE DESIGNATED AREAS AND IT SHALL BE A MINIMUM DEPTH OF SIX INCHES AFTER FIRING. SPREADING SHALL BE PERFORMED IN SUCH A MANNER THAT SEEDING CAN PROCEED WITH A MINIMUM OF ADDITIONAL SOIL PREPARATION AND TILLAGE. ANY IRREGULARITIES IN THE SURFACE RESULTING FROM TOPSOILING OR OTHER OPERATIONS SHALL BE CORRECTED IN ORDER TO PREVENT THE FORMATION OF DEPRESSIONS OR WATER POCKETS. TOPSOIL SHALL NOT BE PLACED WHILE IN A FROZEN OR MUDDY CONDITION, WHEN THE SUBGRADE IS EXCESSIVELY WET, OR IN A CONDITION THAT MAY OTHERWISE BE DETRIMENTAL TO PROPER GRADING OR PROPOSED SEEDING.
3. AFTER LOAM HAS BEEN PLACED, LIME AND FERTILIZER SHALL BE UNIFORMLY MIXED INTO THE TOP FOUR INCHES OF SOIL BY DISING, HARROWING OR USING OTHER APPROVED METHODS.
4. ANY UNDULATIONS OR IRREGULARITIES IN THE SURFACE RESULTING FROM FERTILIZING, LIMING, SURFACE ROUGHENING OR OTHER CAUSES SHALL BE LEVELED PRIOR TO SEEDING. FLOODED, WASHED-OUT OR OTHERWISE DAMAGED AREAS SHALL BE RECONSTRUCTED AND ALL GRADES RE-ESTABLISHED BY THE CONTRACTOR IN ACCORDANCE WITH THE DRAWINGS AND/ OR OTHER APPLICABLE SPECIFICATIONS.
5. PRIOR TO SEEDING THE SURFACE SHALL BE CLEARED OF ALL TRASH, DEBRIS AND STONES LARGER THAN ONE AND ONE-HALF INCHES IN DIAMETER, AND OF ALL ROOTS, BRUSH, WIRE, GRADE STAKES AND OTHER OBJECTS THAT WOULD INTERFERE WITH PLANTING OR MAINTENANCE OPERATIONS.
6. BROADCAST SEED AND MULCH, PLACE STRAW AND ANCHOR IT TO TOPSOIL. IF SOIL MOISTURE IS DEFICIENT, SUPPLY NEW SEEDLINGS WITH ADEQUATE WATER FOR PLANT GROWTH. (1/2"-1" EVERY 3-4 DAYS DEPENDING ON SOIL TEXTURE) UNTIL THEY ARE FIRMLY ESTABLISHED.


REPAIRS AND MAINTENANCE

INSPECT ALL SEEDED AREAS FOR FAILURES AND MAKE NECESSARY REPAIRS, REPLACEMENTS AND RESEEDINGS WITHIN THE PLANTING SEASON.

1. ONCE THE VEGETATION IS ESTABLISHED, THE SITE SHALL HAVE 95% GROUND COVER TO BE CONSIDERED ADEQUATELY STABILIZED.
2. IF THE STAND PROVIDES LESS THAN 40% GROUND COVER, REESTABLISH FOLLOWING ORIGINAL LIME, FERTILIZER, SEEDING PREPARATION AND SEEDING RECOMMENDATIONS.
3. IF THE STAND PROVIDES BETWEEN 40% AND 94% GROUND COVER AGE, OVERSEEDING AND FERTILIZING USING HALF OF THE RATES ORIGINALLY APPLIED MAY BE NECESSARY.

SURFACE PREPARATION


1. STRIP AND STOCKPILE ALL EXISTING LOAM FROM PROPOSED WORK AREAS. PROTECT LOAM FROM EROSION. ALL LOAM WILL REMAIN ON SITE UNLESS THE OWNER APPROVES OFF SITE REMOVAL.
2. SET FIELD GRADES IN ACCORDANCE WITH THE CONTRACT DOCUMENTS. PROVIDE PROPER SURVEY CONTROL AND MAINTAIN THROUGHOUT CONSTRUCTION. PROVIDE ENGINEER WITH COPIES OF ALL SURVEY NOTES AND LOCATIONS OF BOTH VERTICAL AND HORIZONTAL CONTROL.
3. BRING BASE MATERIAL TO FINISH GRADE. PROVIDE ENGINEER WITH AS-BUILT DRAWINGS SHOWING FINISH ELEVATIONS AND CONTOURS PRIOR TO PLACEMENT OF LOAM.
4. SOIL TESTS SHALL BE MADE TO DETERMINE THE EXACT REQUIREMENTS FOR BOTH LIME AND FERTILIZER. SOIL TESTS SHALL BE CONDUCTED BY A STATE LABORATORY OR RECOGNIZED COMMERCIAL LABORATORY. PROVIDE ENGINEER WITH COPY OF TEST RESULTS AND RECOMMENDATIONS FOR LIMING AND FERTILIZING.
5. AFTER THE AREAS TO BE TOPSOILED HAVE BEEN APPROVED BY THE OWNER OR ENGINEER, AND IMMEDIATELY PRIOR TO DUMPING AND SPREADING THE TOPSOIL, THE SUBGRADE SHALL BE LOOSEND BY ROUGHENING TO THE DEPTH OF AT LEAST TWO INCHES TO PERMIT BONDING OF THE TOPSOIL TO THE SUBSOIL AND TO INCORPORATE THE LIME.
6. ACCEPTANCE SHALL BE GIVEN BY THE OWNER OR ENGINEER UPON SATISFACTORY COMPLETION OF EACH SECTION OR AREA AS INDICATED ON THE DRAWINGS OR AS OTHERWISE SPECIFIED BEFORE PLACEMENT OF TOPSOIL.

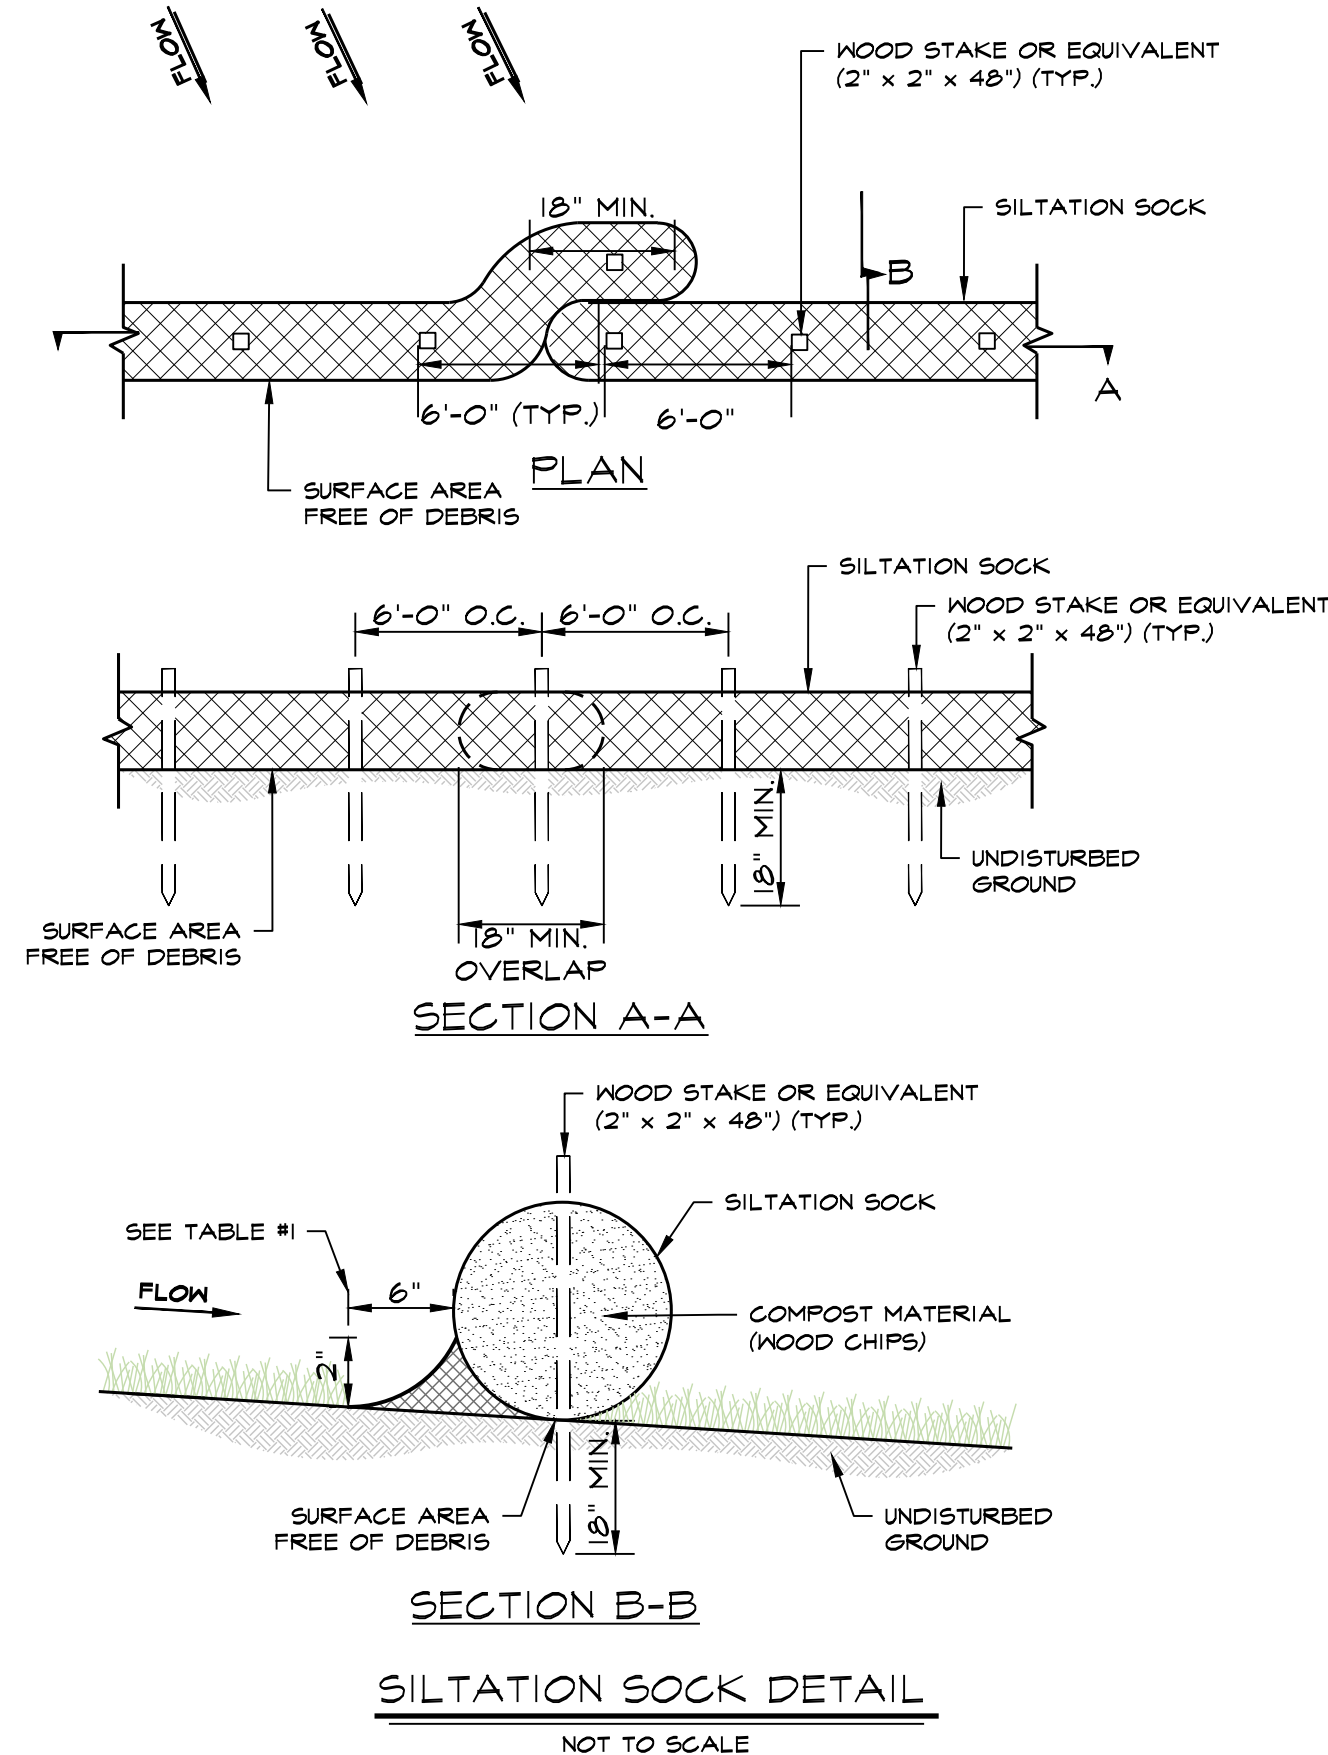

INSTALLATION NOTES:

1. INSTALL SILT SOCK ON A SURFACE CLEAR OF DEBRIS.
2. OVERLAP ENDS BY A MINIMUM OF 18-INCHES.
3. END OF SILT SOCK TO BE DIRECTED UP SLOPE.
4. PLACE STAKES THROUGH SILT SOCK OR ON DOWNSTREAM SIDE.
5. ON SLOPES GREATER THAN 2:1 (H:V) SEED COMPOST SOCK IS RECOMMENDED.

SLOPE	SOCK DIAMETER (MIN.)	STAKING	2" COMPOST BARRIER (WOOD CHIPS)
< 50:1	4"	6' O.C.	---
50:1 TO 10:1	4"	6' O.C.	---
10:1 TO 3:1	12"	6' O.C.	---
3:1 TO 2:1	12"	4' O.C.	---
> 2:1	18"	4' O.C.	---

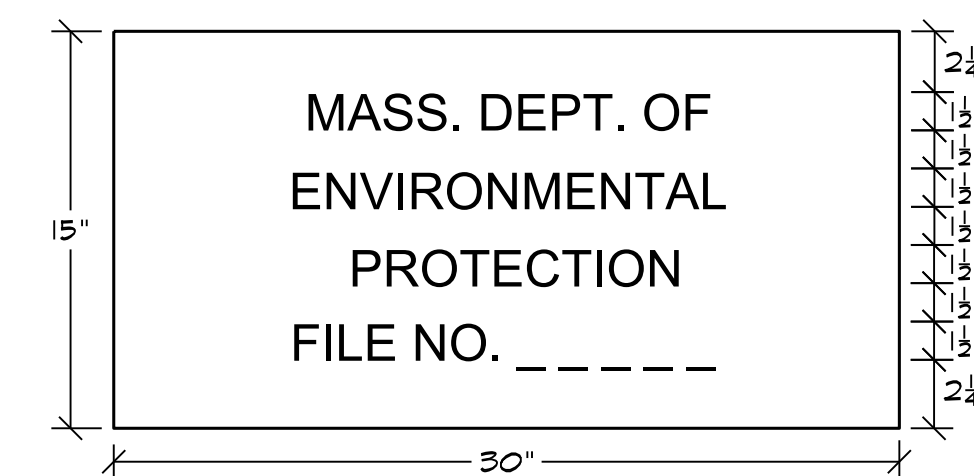


NOTES:


1. **COLOR:** LETTERING = BLACK
BACKGROUND = WHITE
2. THE SIGN IS TO BE PLACED ON ALL PROJECTS SUBJECT TO THE PROVISIONS OF THE MASSACHUSETTS WETLAND PROTECTION ACT.
3. THE LOCATION OF THE SIGN IS TO BE DETERMINED BY THE ENGINEER.

MASSDEP SIGN DETAIL


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LOAM & SEED DETAIL

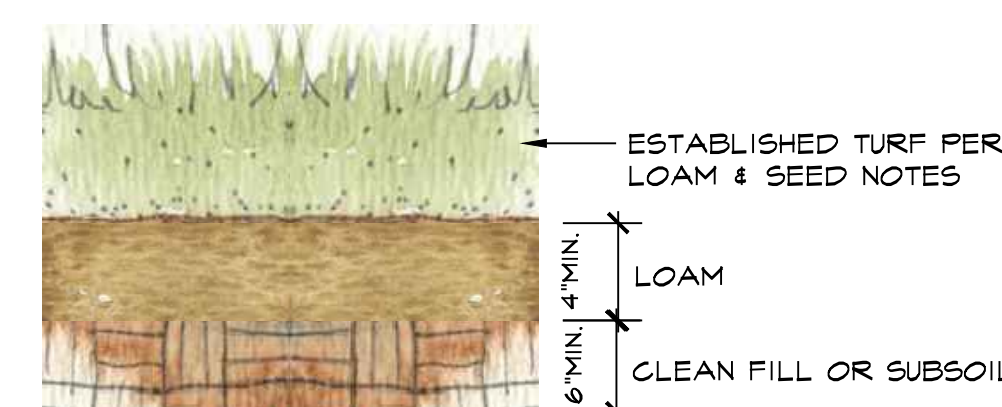

SECTION A - A

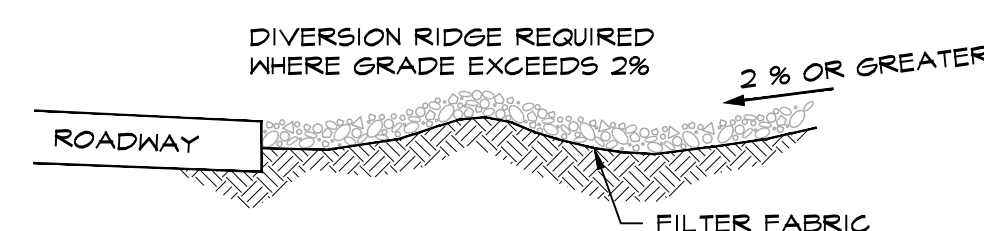

PLAN

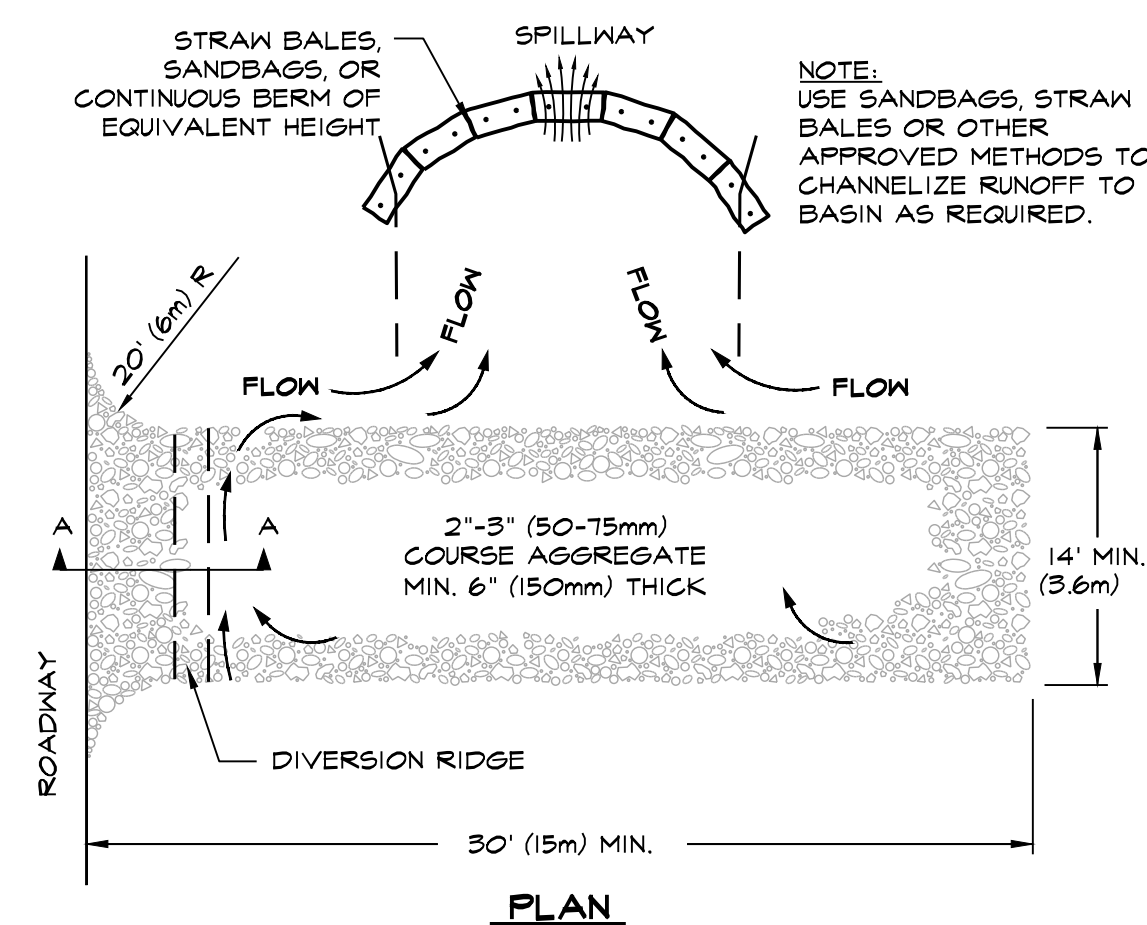NOTES:

1. THE ENTRANCE SHALL BE MAINTAINED IN A CONDITION THAT WILL PREVENT TRACKING OR FLOWING OF SEDIMENT ONTO PUBLIC RIGHT-OF-WAYS. THIS MAY REQUIRE TOP DRESSING, REPAIR AND/OR CLEANOUT OF ANY MEASURES USED TO TRAP SEDIMENT.
2. WHEN NECESSARY, WHEELS SHALL BE CLEANED PRIOR TO ENTRANCE ONTO PUBLIC RIGHT-OF-WAY.
3. ADJACENT STREETS SHALL BE SWEEPED.

TEMPORARY CONSTRUCTION ENTRANCE

NOT TO SCALE